FREDERICK COUNTY

HEALTH DEPARTMENT

Town Engineer

Town of Mount Airy

Planning Commission

APPROVAL

CONCEPT SITE PLAN LOT 18A, SECTION II

RISING RIDGE ROAD


18TH ELECTION DISTRICT * TOWN OF MOUNT AIRY

OWNER

DEVELOPER

LDG RIDGEVILLE LLC LEE PLAZA 8601 GEORGIA AVENUE, SUITE 200 SILVER SPRING, MD 20910 (301) 585-7000

LEE PLAZA 8601 GEORGIA AVENUE, SUITE 200 SILVER SPRING, MD 20910 (301) 585-7000

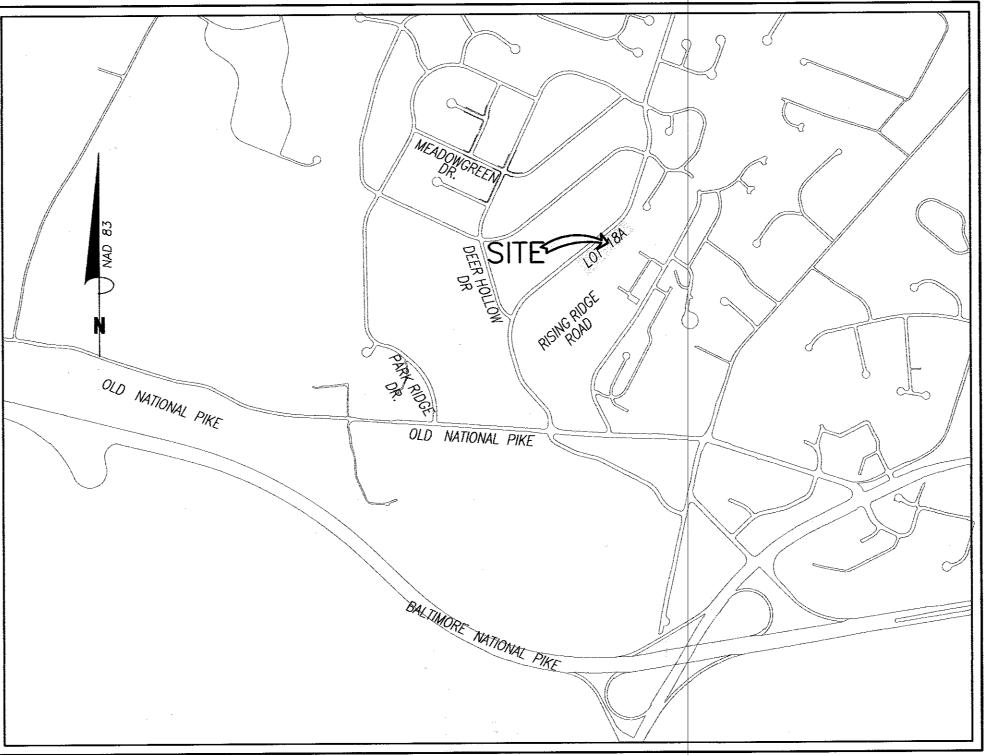

LOCATION MAP

SITE DEVELOPMENT PLAN INSPECTION SEQUENCE NOTES

1. THE CONTRACTOR SHALL NOTIFY AND SCHEDULE A PRECONSTRUCTION MEETING AT LEAST ONE WEEK PRIOR TO THE START OF ANY CONSTRUCTION. PRECONSTRUCTION MEETING SHALL INCLUDE TOWN ENGINEER, TOWN INSPECTOR, CONSTRACTOR AND DEVELOPER / OR CONSTRUCTION MANAGER.

2. CONTRACTOR SHALL INSTALL SEDIMENT CONTROL.

3. CONTRACTOR SHALL NOTIFY CARROLL COUNTY BUREAU OF RESOURCE MANAGEMENT, ENVIRONMENTAL INSPECTION SERVICES DIVISION AT 410-386-2210 PRIOR TO BEGINNING WORK, ALL FOREST CONSERVATION PLAN DEVICES MUST BE IN PLACE PRIOR TO ANY CONSTRUCTION.

4. CONTRACTOR SHALL NOTIFY THE TOWN ENGINEER, TOWN INSPECTOR, AND CARROLL COUNTY BUREAU OF PERMITS AND INSPECTIONS AT 410-386-2674, AT LEAST ONE DAY PRIOR TO BEGINNING ANY WORK REQUIRING SITE COMPLIANCE INSPECTIONS.

5. SITE COMPLIANCE INSPECTIONS ARE REQUIRED AT THE FOLLOWING STAGES DURING CONSTRUCTION. 5:1 PROPOSED STRUCTURES STAKED OUT IN PROPER LOCATIONS AS \$HOWN ON THESE APPROVED

5:2 PROPOSED FOUNDATIONS INSTALLED FOR ALL BUILDINGS SHOWN ON THESE APPROVED PLANS. IT IS THE CONTRACTOR'S RESPONSIBILITY TO CONTACT THE CARROLL COUNTY BUREAU OF PERMITS AND INSPECTIONS AT 410-386-2674 UPON COMPLETION OF EACH PHASE OF CONSTRUCTION. 5:3 SUB-GRADES ESTABLISHED FOR ALL DRIVES, PARKING LOTS, AND SURROUNDING GRADING.

5:4 A "FORM" INSPECTION ON ALL ACCESSIBLE ROUTES/RAMP/CURB RAMPS SHALL BE COMPLETE BEFORE PLACEMENT OF FINAL MATERIAL.

5:5 COMPLETION OF ALL DRIVES, PARKING LOTS AND SURROUNDING GRADING.

5:6 COMPLETION OF ALL WORK SHOWN ON PLANS. 5:7 THE CONTRACTOR SHALL NOT PROCEED TO THE NEXT PHASE OF CONSTRUCTION UNTIL GIVEN APPROVAL

OF PRIOR PHASES.

6. FINAL LANDSCAPING INSPECTION SHALL BE ARRANGED BY NOTIFYING THE TOWN OF MOUNT AIRY AT (301) 829-1424. WRITTEN APPROVAL FROM THE TOWN MUST BE OBTAINED FOR ANY DEVIATIONS FROM

7. STABILIZE ALL DISTURBED AREAS AS PER PERMANENT SEEDING NOTES.

SEDIMENT CONTROL DEVICES AND STABILIZE ALL DISTURBED AREAS AS PER PERMANENT SEEDING NOTES.

PROFESSIONAL CERTIFICATION hereby certify that these documents were prepared or approved by m and that I am a duly licenced professional engineer under the laws of the State of Maryland, License No. 18417, Expiration Date: 9/18/23. **REVISIONS**

8. UPON APPROVAL FROM SEDIMENT CONTROL INSPECTOR, REMOVE ALL TOWN & COUNTY COMMENTS 9/28/2021 1/3/2022 TOWN COMMENTS ASSOCIATES, INC. Engineers Surveyors Planners 310 South Main Street P.O. box 328 Mount Airy, Maryland 21771 (301) 829 2890 (301)831 5015 (410) 549 2751

SITE DEVELOPMENT DATA

1. THE PROPERTY SHOWN HEREON IS OWNED BY: LDG RIDGEVILLE LLC RECORDED AMONG THE LAND RECORDS OF FREDERICK COUNTY MD. IN L. 13701 F. 225 DATED 04/03/2020 TAX MAP 90B, PARCEL 1408 PB 74 PAGE 119

2. EXISTING ZONING: INDUSTRIAL I-ZONE 3. EXISTING USE: VACANT

FLEX INDUSTRIAL

4. PROPOSED USE: FLEX INDUSTRIAL 5. TOTAL AREA OF PROPERTY: 3.42 AC±.

6. TOTAL DEVELOPED (IMPERVIOUS) AREA OF PROPERTY: 2.466 AC/107,437 S.F. . PARKING REQUIREMENTS: TYPE OF USE GROSS SQUARE FEET REQUIRED PARKING SPACES

3,5 SPACES / 1000 S.F.

28,800

8. PARKING PROVIDED: 101 SPACES 101 PARKING SPACES (INCLUDES 6 HANDICAP SPACES) 3 LOADING SPACES (12'X45')

9. TRAFFIC GENERATION - GENERAL LIGHT INDUSTRIAL AM PEAK HOUR = 0.92 / 1,000 S.f. = 0.92 / 28.8 = 27 TRIPSPM PEAK HOUR = 0.83 / 1,000 S.F. = 0.83 / 28.8 = 24 TRIPS

10. MINIMUM BUILDING RESTRICTION LINES FRONT:40' / SIDE:25' / REAR:40'

11. SITE IS SERVED BY PUBLIC WATER AND SEWER EMPLOYEES = 40

EST. WATER FLOW = 2016 GPD EST. SEWER FLOW = 2016 GPD

12. TOPOGRAPHY SHOWN HEREON TAKEN FROM COPYRIGHTED GIS DATA FROM CARROLL COUNTY, FIELD CHECKED BY VANMAR ASSOC. OCTOBER. 2012. VERTICAL DATUM NAVD88.

13. SOIL CLASSIFICATION MAP NO. 51 14. THE HORIZONTIAL AND VERTICAL CONTROL IS BASED ON NAD-83-(91), AS PROJECTED BY C. C.

MONUMENTS "WATKINS & WATKINS AZIMUTH". TOPOGRAPHY SHOW HEREON IS AERIAL BY POTOMAC SURVEYS DATED 3/98. CONTROL INTERVAL IS 2 FEET, FIELD UPDATED BY VMA. APRIL 2006. 15. NEAREST WATER SUPPLY IS ADJACENT TO SITE IN RISING RIDGE ROAD

16. SITE PLAN INCLUDING ALL GRADING, STORMWATER MANAGEMENT, UTILITY, FOREST CONSERVATION, AND PARKING REQUIREMENTS HAVE BEEN DEVELOPED FOR THE PROPOSED BUILDING.

17. A SIX-FOOT DRAINAGE AND UTILITY EASEMENT IS HEREBY RESERVED ALONG ALL LOT LINES.

STORMWATER MANAGEMENT

STORMWATER MANAGEMENT REQUIREMENTS ARE PROVIDED FOR/SATISFIED IN SWM POND #4 THE SWM ESD TO MEP REQUIREMENTS FOR LOT 18A WILL BE ADDRESSED USING (M-6) MICRO BIORETENTION AND (M-9) ENHANCED FILTERS (STORM GARDEN). STORMWATER MANAGEMENT IS IN ACCORDANCE WITH THE 2009 REVISIONS OF THE 2000 MARYLAND STORMWATER DESIGN MANUAL.

A "STORMWATER MANAGEMENT EASEMENT AND MAINTENANCE AGREEMENT" IS TO BE GRANTED TO THE TOWN OF MOUNT AIRY AS AN EASEMENT OF ACCESS TO THE TOWN OF MOUNT AIRY OR AUTHORIZED REPRESENTATIVES BY A DEED INTENDED TO BE RECORDED SIMULTANEOUSLY HEREWITH.

FOREST CONSERVATION

PRELIMINARY PLAN OF SUBDIVISION APPROVED 2/28/1991, PER CHAPTER 150.21, THE SITE PLAN IS EXEMPT FROM TH PROVISIONS OF CHAPTER 150 FOREST CONSERVATION.

WATER RESOURCE PROTECTION

THE PROPERTY IS LOCATED WITHIN AN AQUIFER PROTECTION AREA. THERE IS NO PLANED USE, TRANSFER AND/OR STORAGE OF HAZARDOUS OR REGULATED SUBSTANCES TO THE GROUND WATER, STORMWATER MANAGEMENT SYSTEM OR DRAINAGE SYSTEM.

ANY CHANGES TO THIS PLAN WILL REQUIRE AN AMENDED SITE DEVELOPMENT PLAN TO BE APPROVED BY THE TOWN OF MOUNT AIRY PLANNING COMMISSION. THIS SITE PLAN SHALL BECOME VOID EIGHTEEN MONTHS AFTER THE DATE OF APPROVAL IF NO BUILDING PERMIT OR ZONING

CERTIFICATE HAS BEEN ISSUED FOR THIS PROJECT UNLESS AN EXTENSION OF THIS TIME LIMIT IS ISSUED BY TOWN OF THE MOUNT AIRY PLANNING COMMISSION. PROPOSED LIGHTING TO BE PROVIDED AND ATTACHED TO THE PROPOSED STRUCTURE. LIGHTS TO BE SHIELDED SO AS TO

PREVENT GLARE TO ADJACENT PROPERTIES, IN COMPLIANCE WITH THE TOWN LIGHTING ORDINANCE. HANDICAPPED PARKING SIGNS SHALL BE 7' FROM BOTTOM OF SIGN TO GROUND. CONTRACTOR SHALL CONFIRM THAT ALL UTILITIES ARE INSTALLED PRIOR TO PAVING AND PLACEMENT OF CONCRETE. . THE CONTRACTOR SHALL NOTIFY "MISS UTILITY" AT 1-800-257-7777 THREE (3) WORKING DAYS PRIOR TO BEGINNING ANY WORK

IN THE VICINITY OF THE UTILITIES. DEVELOPER SHALL BE BILLED FOR ANY MISS UTILITY CHARGES INCURRED BY THE TOWN RELATED TO THIS WORK THE LOCATION OF EXISTING UTILITIES SHOWN HEREON ARE APPROXIMATE ONLY. CONTRACTOR SHALL EXCAVATE TO VERIFY THE EXISTENCE, LOCATION, AND DEPTH OF ANY UTILITIES (CONSTRUCTED AND EXISTING) AND SHALL NOTIFY THE ENGINEER OF ANY

DISCREPANCIES PRIOR TO THE BEGINNING OF ALL WORK, EXCAVATION, GRADING, LANDSCAPING, ETC... MANHOLES, ETC., TO BE RAISED, LOWERED OR REMOVED, ARE TO BE DONE SO BY THE CONTRACTOR. CONTRACTOR SHALL FIELD VERIFY ALL LOCATIONS AND ELEVATIONS PRIOR TO CONSTRUCTION. ANY UTILITY (WHETHER SHOWN OR NOT) DAMAGED DUE TO CONSTRUCTION SHALL BE REPAIRED IMMEDIATELY. THE CONTRACTOR SHALL BE RESPONSIBLE FOR

REMOVING OR REPLACING ANY EXISTING FENCES, DRIVEWAYS, ETC., DAMAGED OR REMOVED BY THE CONTRACTOR DURING CONSTRUCTION. ALL OFF-SITE DISTURBED AREAS SHALL BE RETURNED TO THEIR ORIGINAL CONDITION. PLACEMENT OF ANY CONCRETE OR ASPHALT WORK SUCH AS CURB/GUTTER/SIDEWALKS/DRIVEWAY APRONS, ETC., SHALL BE

COMMENCED ONLY AFTER THE INSTALLATION OF ALL UTILITIES INCLUDING GAS LINES/ELECTRICAL LINES/ STREET LIGHT CONDUITS/TELEVISION CABLE/WATER AND SEWER LINES, ETC. ARE IN PLACE. 10. ALL EXISTING PAVING DISTURBED BY THE CONTRACTOR'S OPERATION SHALL BE REPLACED IN ACCORDANCE WITH TOWN OF MOUNT

AIRY STANDARDS. 1. THE CONTRACTOR SHALL BE RESPONSIBLE FOR THE MAINTENANCE OF TRAFFIC ON EXISTING ROADS IN ACCORDANCE WITH MUTCD SPECIFICATIONS. THE CONTRACTOR SHALL OBTAIN PERMITS FROM THE TOWN OF MOUNT AIRY FOR ALL NECESSARY WORK NOT

PERMITTED BY THE OWNER. 12. SHOULD THE CONTRACTOR DISCOVER DISCREPANCIES BETWEEN THE PLANS AND FIELD CONDITIONS, THE "WORK" SHALL BE STOPPED IMMEDIATELY AND THE ENGINEER NOTIFIED IMMEDIATELY TO RESOLVE THE SITUATION. SHOULD THE CONTRACTOR MAKE FIFLD CORRECTIONS OR ADJUSTMENTS WITHOUT NOTIFYING THE ENGINEER, THEN THE CONTRACTOR ASSUMES ALL RESPONSIBILITY

AND LIABILITY FOR THOSE CHANGES. 13. DISCREPANCIES FOUND BETWEEN THESE PLANS AND WORK THAT WOULD NORMALLY BE REQUIRED TO COMPLETE THE PROJECT SHALL NOT RELIEVE THE CONTRACTOR OF HIS RESPONSIBILITY TO PERFORM SUCH WORK. 14. FIELD ADJUSTMENTS SHALL BE MADE AS NECESSARY TO PROVIDE A SMOOTH TRANSITION

15. AS-BUILT CONTRACT DOCUMENT SET MUST BE MAINTAINED ON SITE THROUGH THE PROJECT. THE AS-BUILT DRAWINGS SHALL SHOW CHANGES TO PUBLIC WATER OR SEWER LINES, PUBLIC STORM DRAINAGE SYSTEMS, SIDEWALKS AND STREETS THAT ARE MAINTAINED BY THE TOWN OF MOUNT AIRY. HORIZONTAL VARIATIONS GREATER THAN 1.0 FOOT AND 0.2 FEET FOR VERTICAL FI FVATIONS SHALL BE SHOWN ON THE PLANS. THE DEVELOPER SHALL SUBMIT ONE SET OF AS-BUILT MYLARS AND ONE SET O AS-BUILT PRINTS TO THE TOWN WITHIN 90 DAYS OF PROJECT COMPLETION.

SHEET INDEX TITLE SHEET TITLE SHEET 1 OF 11 **EXISTING CONDITIONS** 2 OF 11 3 OF 11 SITE LAYOUT & UTILITY PLAN STORMWATER MANAGEMENT, GRADING & SEDIMENT CONTROL PLAN 4 OF 11 STORMWATER MANAGEMENT/STORM DRAINAGE DETAILS 5 OF 11 STORMWATER MANAGEMENT/STORM DRAINAGE DETAILS 6 OF 11 SEDIMENT CONTROL NOTES & DETAILS AND DRAINAGE AREA MAPS 7 OF 11 SITE DETAILS & PHOTOMETRIC PLAN 8 OF 11 9 OF 11 SITE DETAILS LANDSCAPE PLAN 10 OF 11 11 OF 11 ARCHITECTURAL ELEVATIONS

CARROLL COUNTY FILE # S-20-0033


CONCEPT SITE PLAN COVER SHEET


LOT 18A, SECTION II LDG RIDGEVILLE LLC TWIN RIDGE PROFESSIONAL PARK

TAX MAP: 90B, PARCEL 1408 PB 74. PG.119 SITUATED ON RISING RIDGE ROAD , TOWN OF MOUNT AIRY 18TH ELECTION DISTRICT

FREDERICK COUNTY, MARYLAND SCALE: AS SHOWN AUGUST 2021 SHEET NO. 1 OF 11

VMA# 251-569

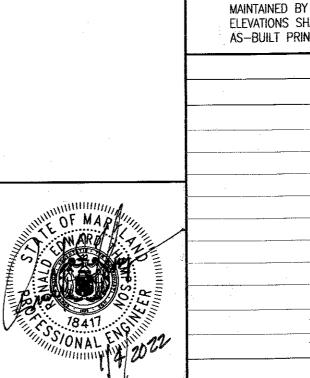

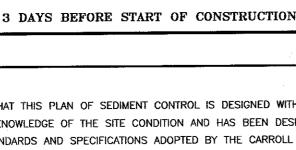

ENGINEER

CALL "MISS UTILITY" AT

1-800-257-7777

I CERTIFY THAT THIS PLAN OF SEDIMENT CONTROL IS DESIGNED WITH MY PERSONAL KNOWLEDGE OF THE SITE CONDITION AND HAS BEEN DESIGNED TO THE STANDARDS AND SPECIFICATIONS ADOPTED BY THE CARROLL SOIL CONSERVATION DISTRICT.

/WE HEREBY CERTIFY THAT ALL PROPOSED WORK SHOWN ON THESE

CONSTRUCTION DRAWING (S) HAS BEEN REVIEWED BY ME/US AND

THIS WORK AND THAT THE WORK WILL BE CONDUCTED IN STRICT

THAT I/WE FULLY UNDERSTAND WHAT IS NECESSARY TO ACCOMPLISH

ACCORDANCE WITH THESE PLANS. I/WE ALSO UNDERSTAND THAT ANY

CHANGES TO THESE PLANS WILL REQUIRE AN AMENDED PLAN TO BE

AND ZONING COMMISSION BEFORE ANY CHANGE IN THE WORK IS MADE

I/WE AGREE TO REIMBURSE THE TOWN OF MOUNT AIRY, ITS REASONABL ATTORNEY'S FEES AND COSTS INCURRED TO SUCCESSFULLY ENFORCE THIS SITE PLAN, INCLUDING THROUGH LITIGATION.

REVIEWED AND APPROVED BY THE TOWN OF MOUNT AIRY PLANNING

RONALD E. THOMPSON

OWNER'S CERTIFICATION

NAME(S) PRINTED

PROFESSIONAL ENGINEER REGISTRATION No.

DATE

AS SPELLED OUT IN THIS PLAN, AND THAT ANY RESPONSIBLE PERSONNEL INVOLVED IN


THIS CONSTRUCTION PROJECT WILL HAVE A CERTIFICATION OF ATTENDANCE AT MARYLAND DEPARTMENT OF ENVIRONMENT APPROVED TRAINING PROGRAM FOR THE CONTROL OF SEDIMENT AND EROSION BEFORE BEGINNING THE PROJECT. I ALSO AUTHORIZE PERIODIC ON-SITE EVALUATION BY THE CARROLL SOIL CONSERVATION DISTRICT PERSONNEL AND COOPERATING AGENCIES.


NAME(S) PRINTED DATE SIGNED


THIS PLAN IS APPROVED FOR SOIL EROSION AND SEDIMENT CONTROL BY THE CARROLL SOIL CONSERVATION DISTRICT.


CARROLL SOIL CONSERVATION DISTRICT


I CERTIFY THAT THIS PLAN OF SEDIMENT CONTROL WILL BE IMPLEMENTED TO THE FULLEST EXTENT, AND ALL STRUCTURES WILL BE INSTALLED TO THE DESIGN AND SPECIFICATIONS

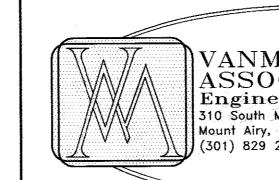


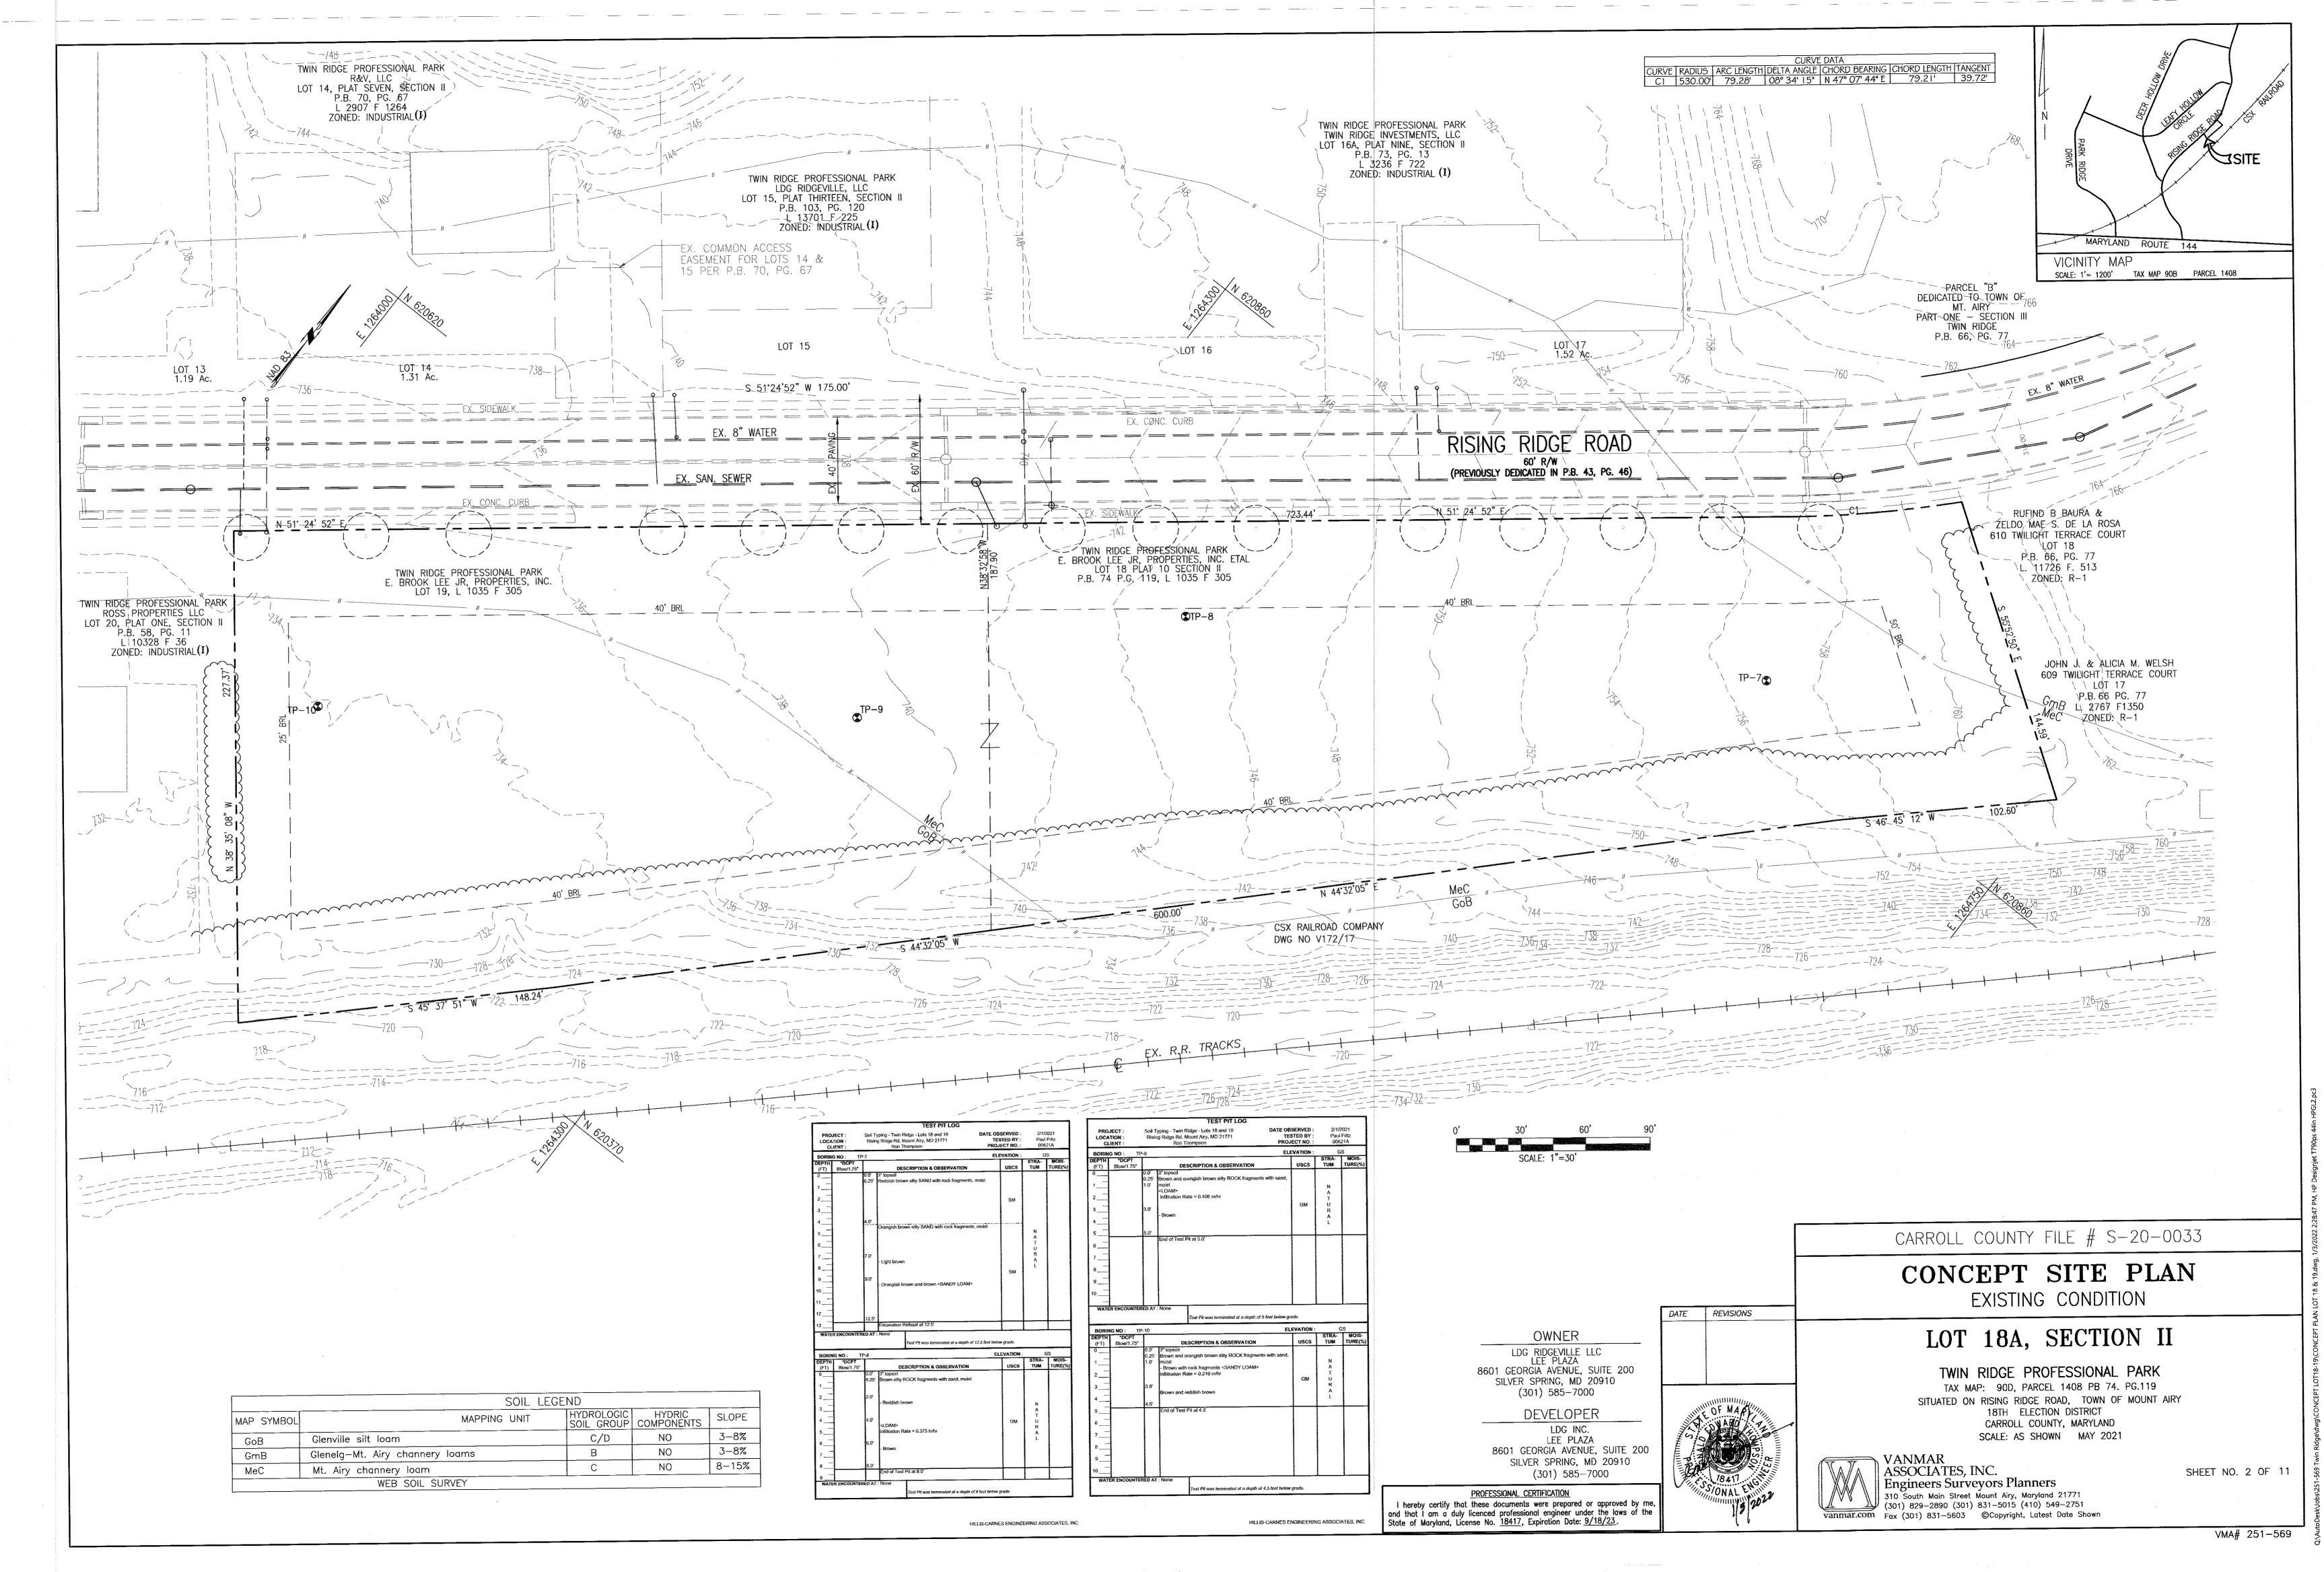


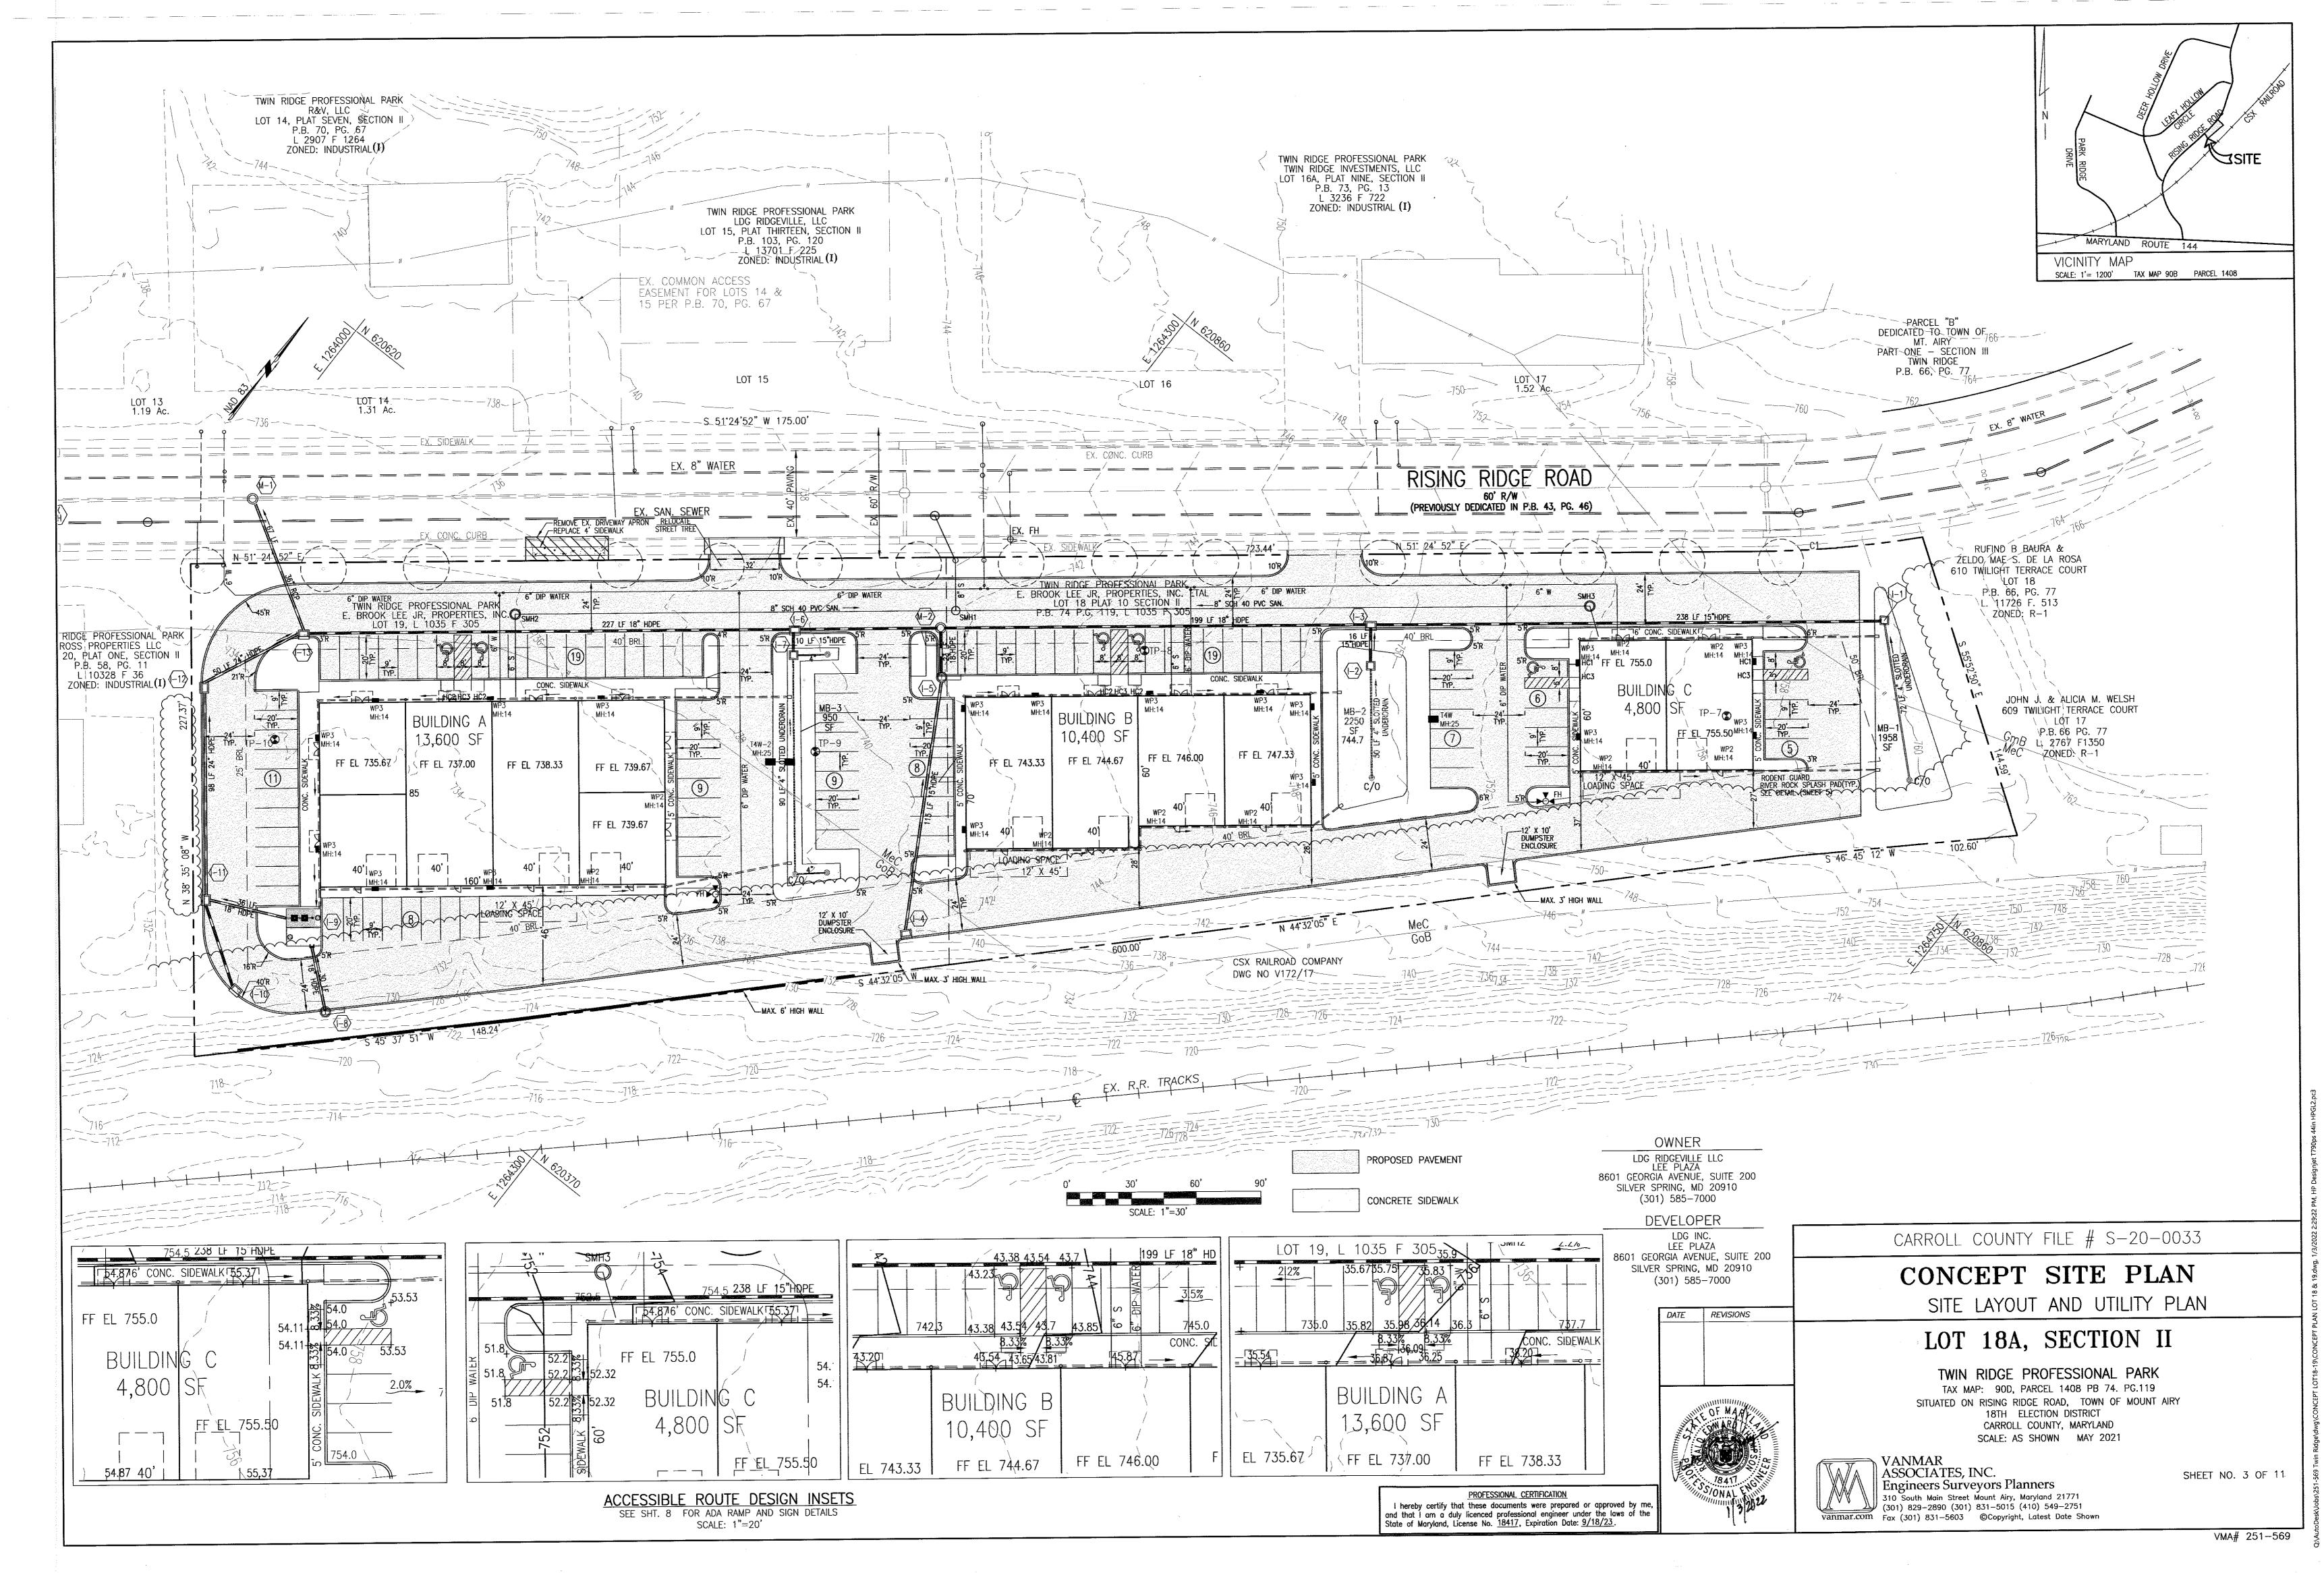

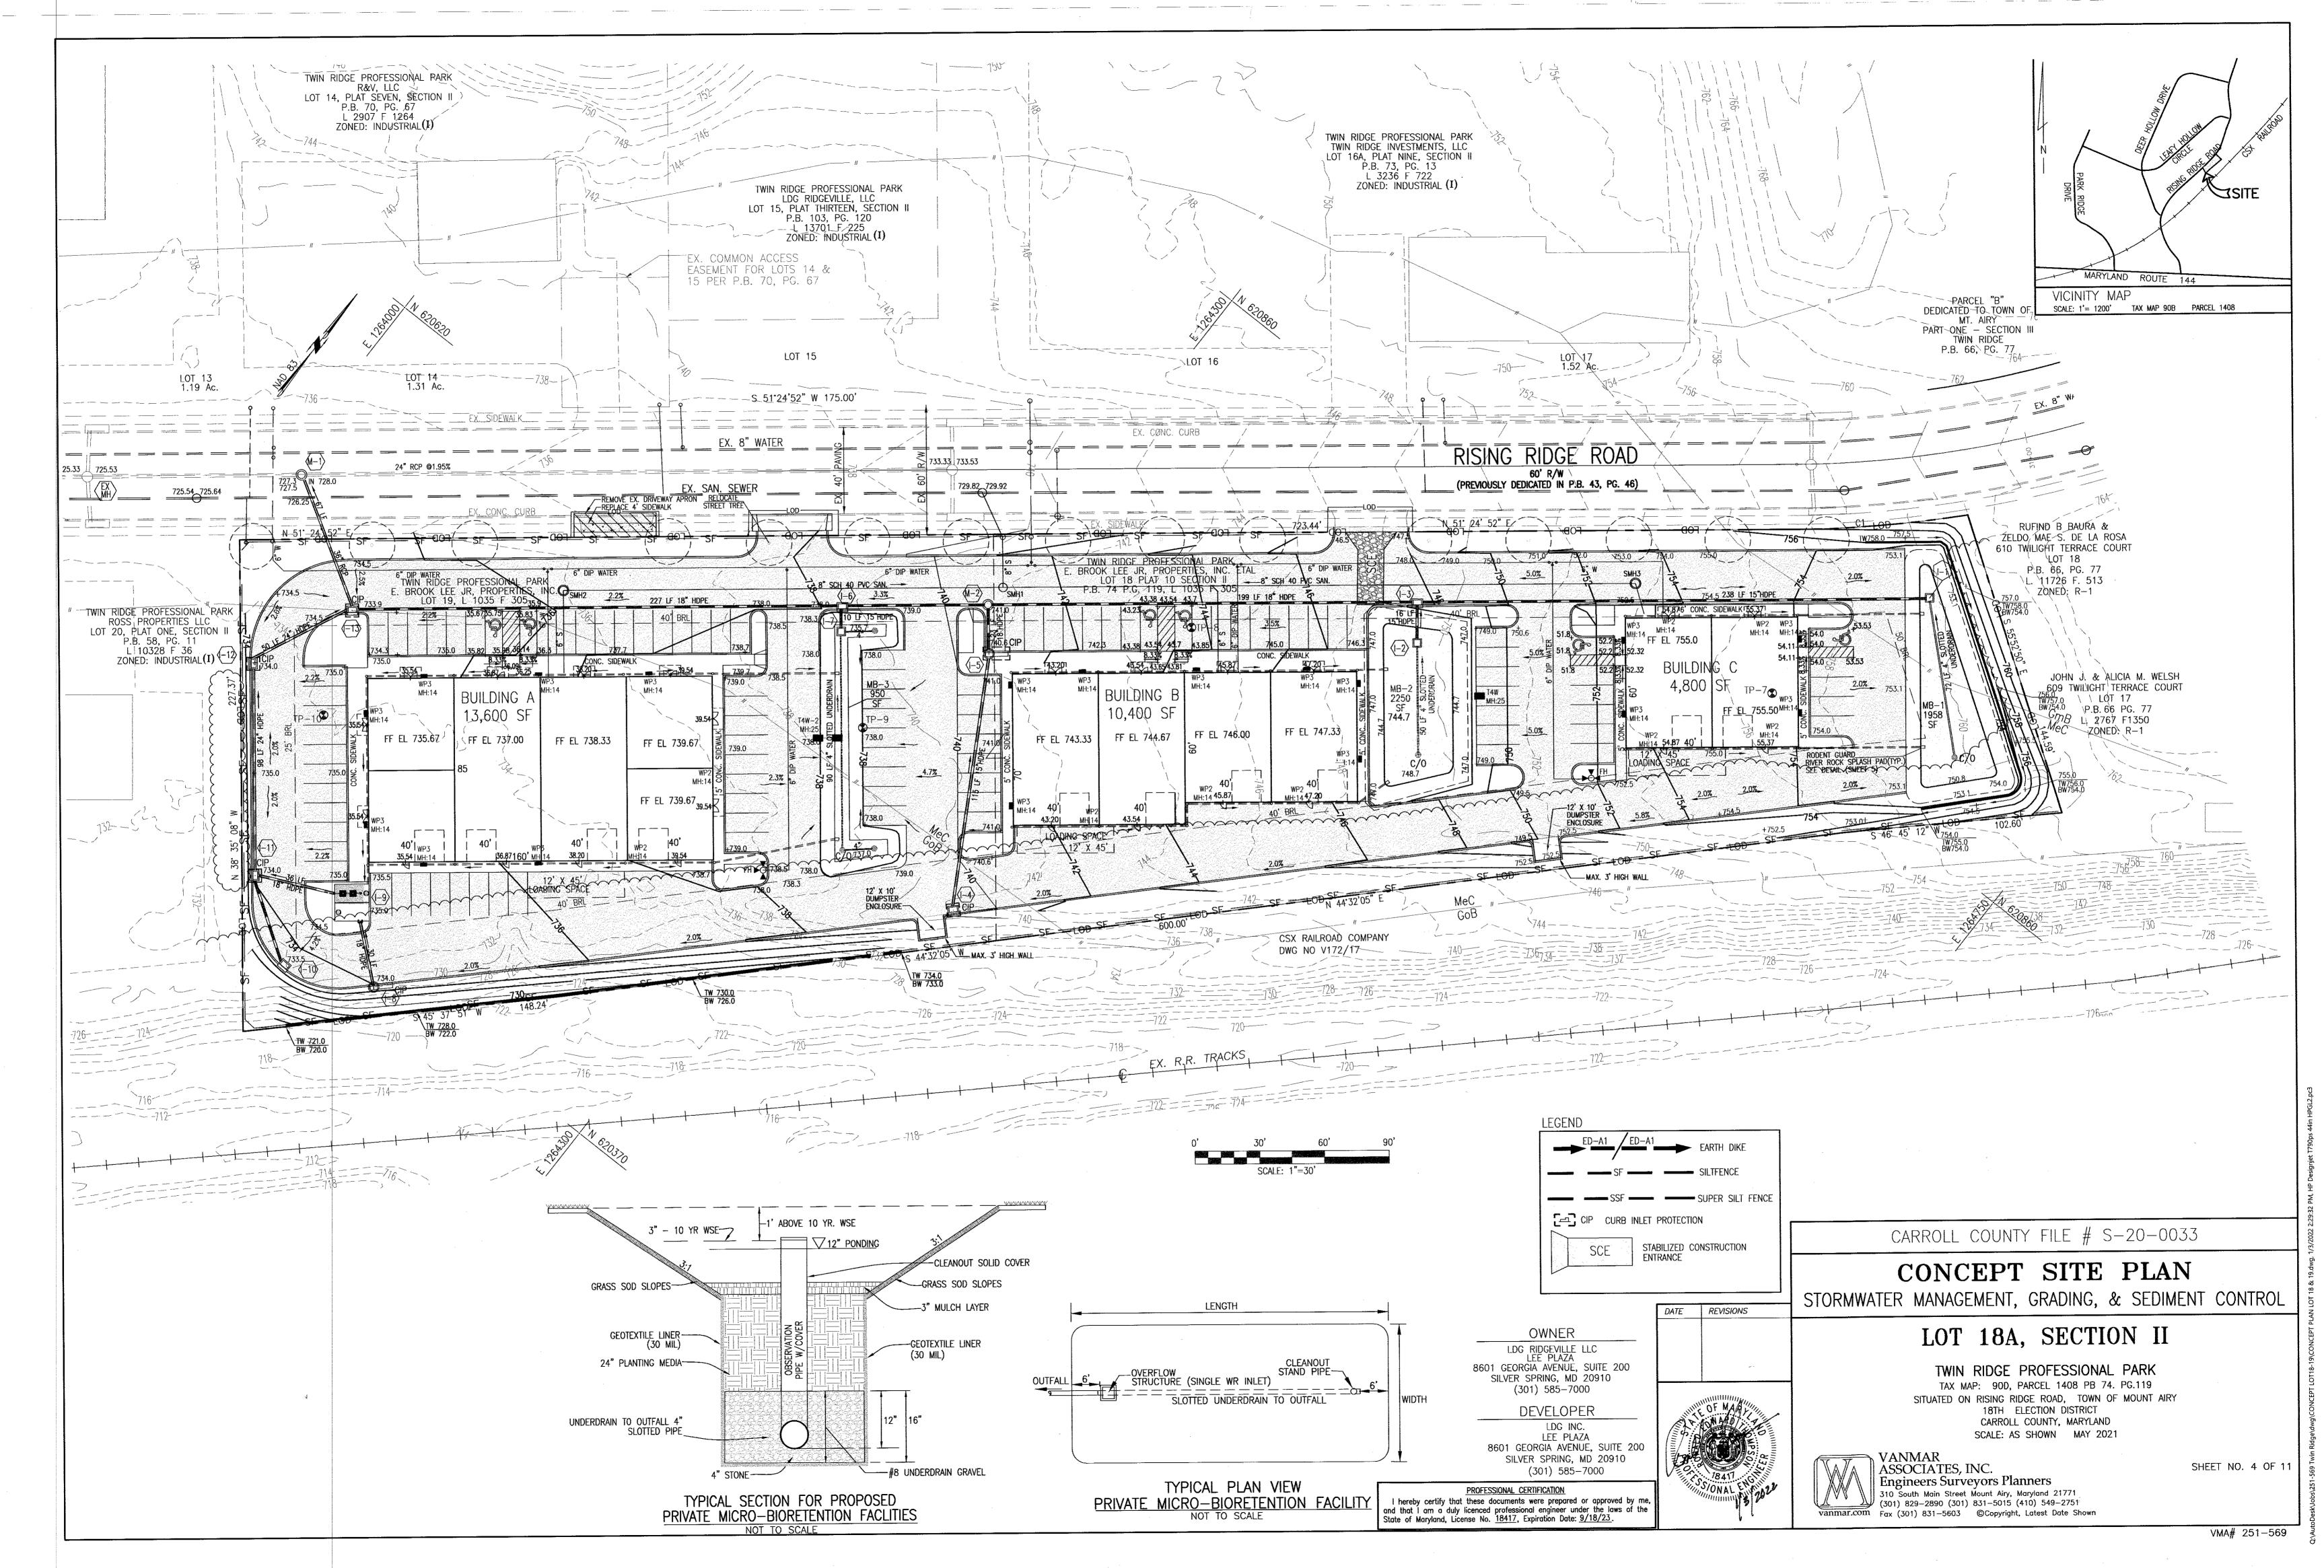

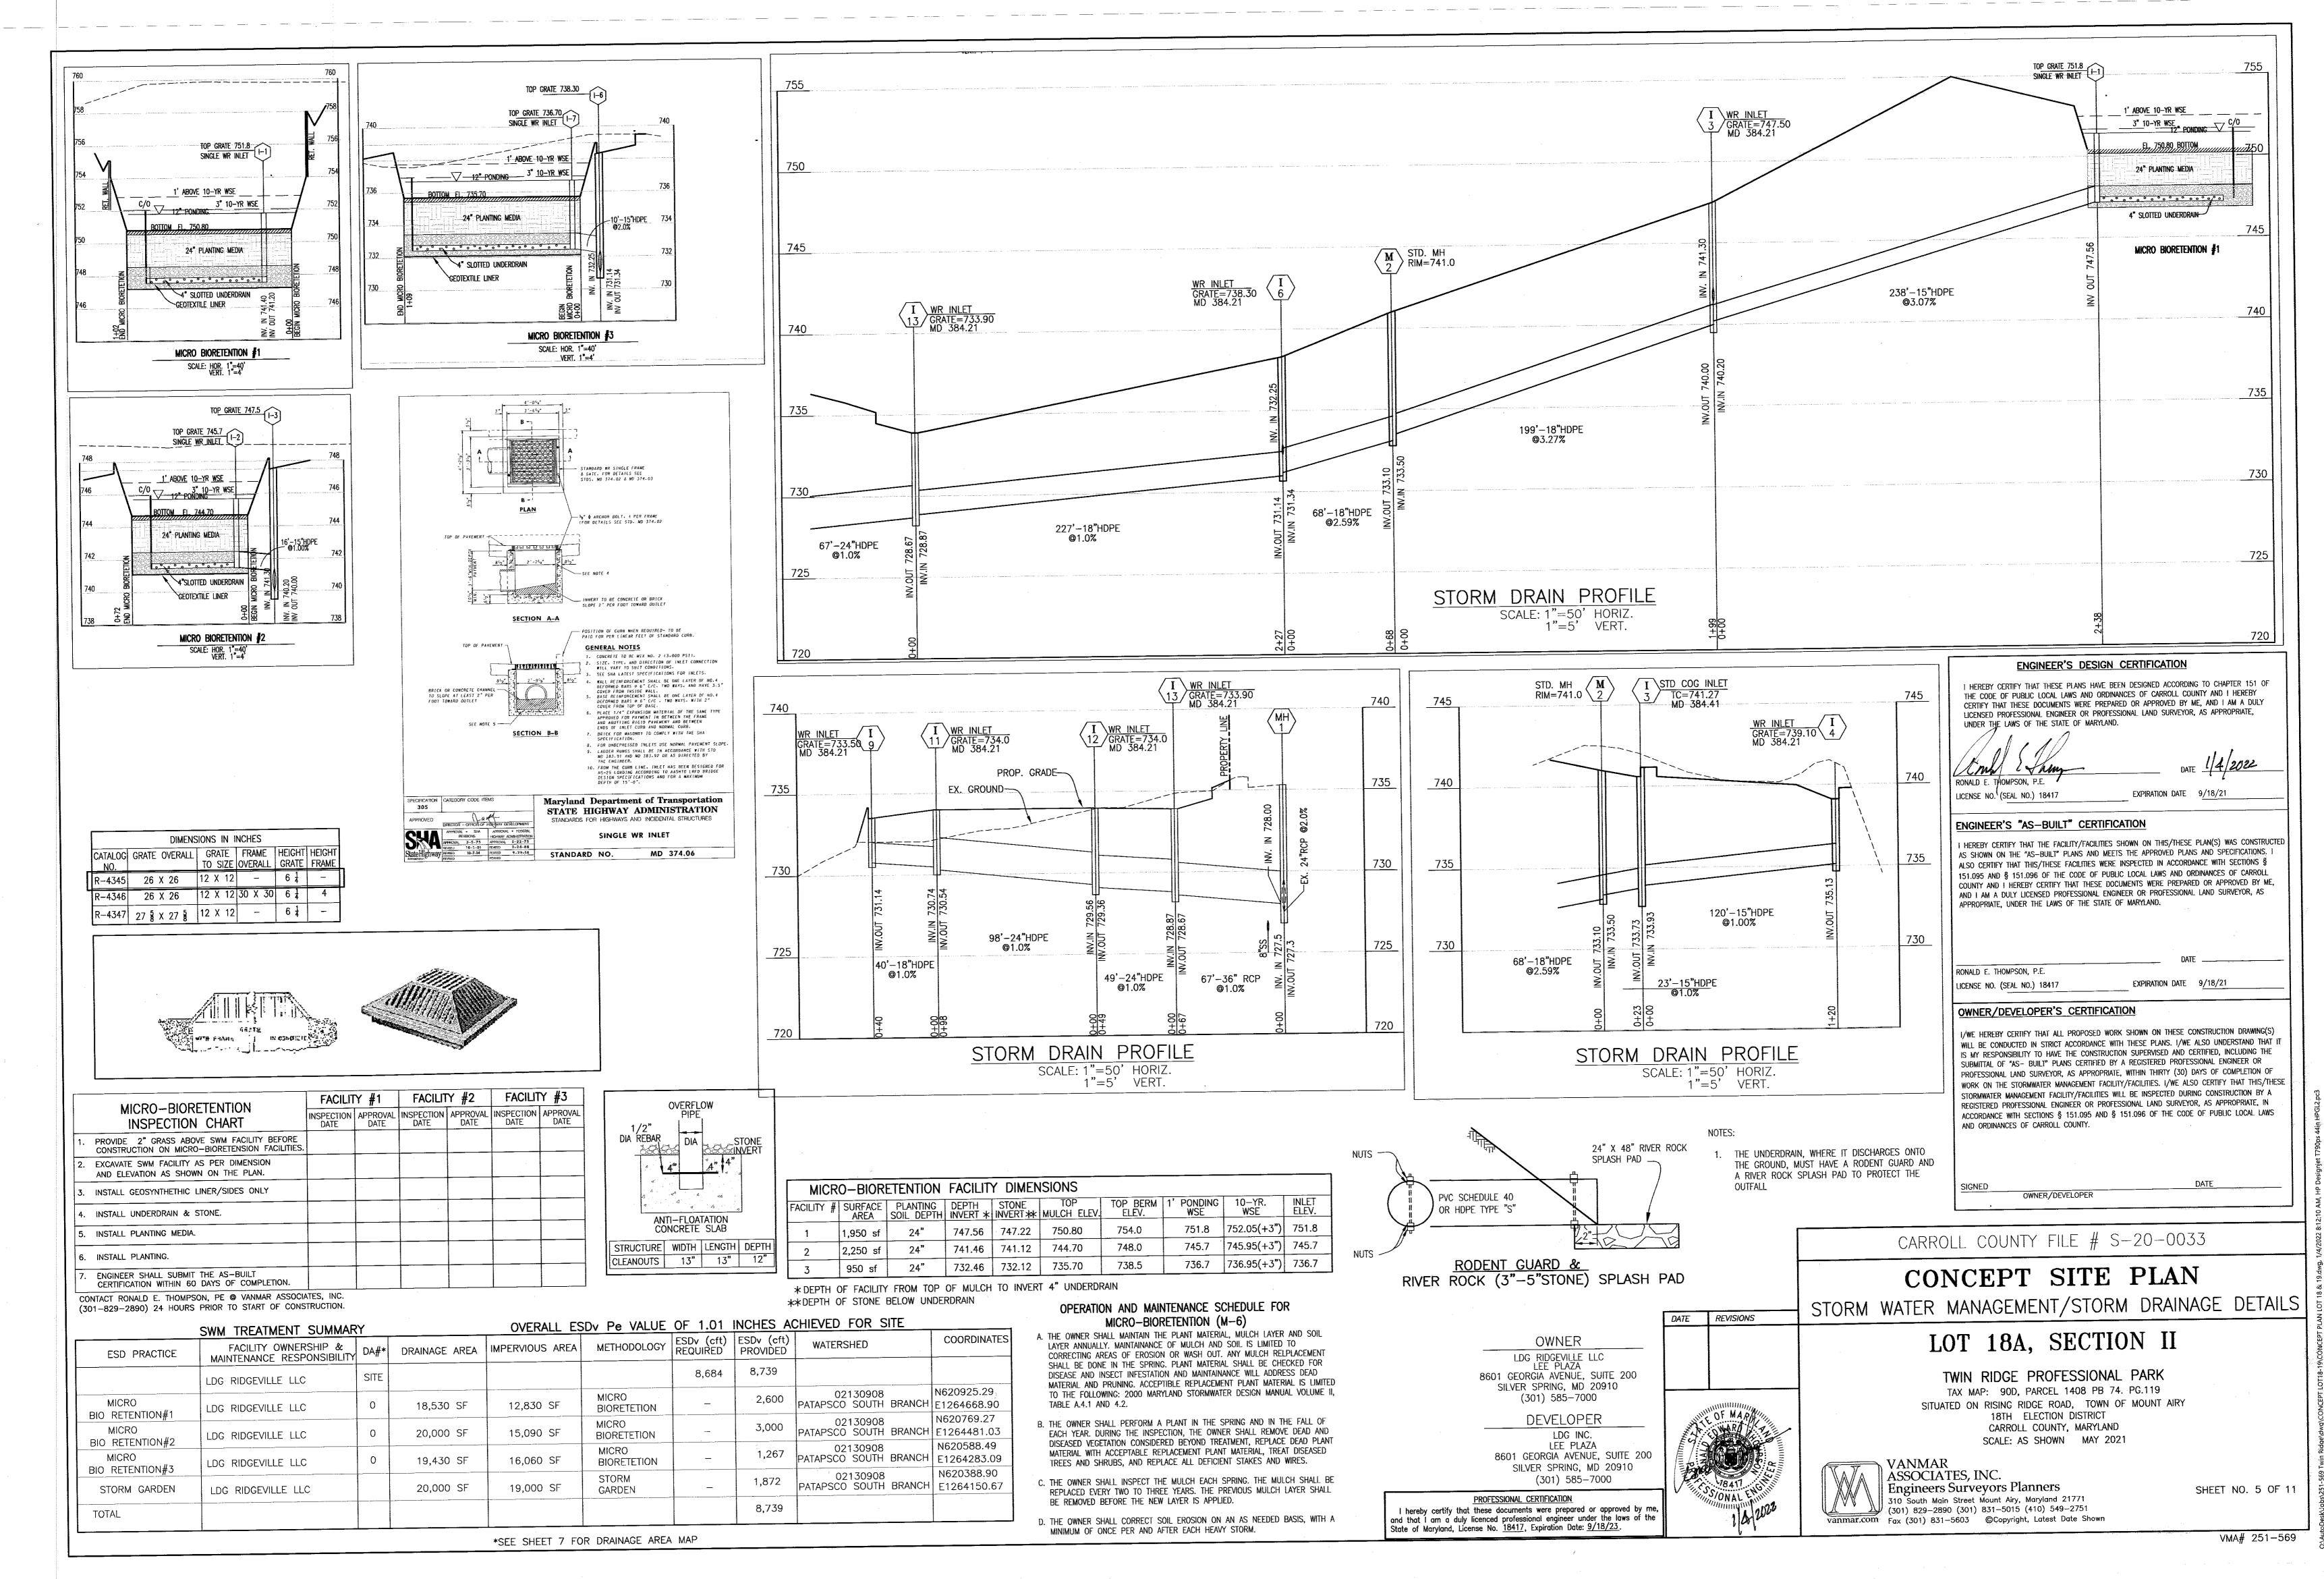

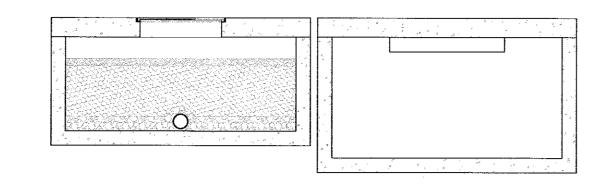


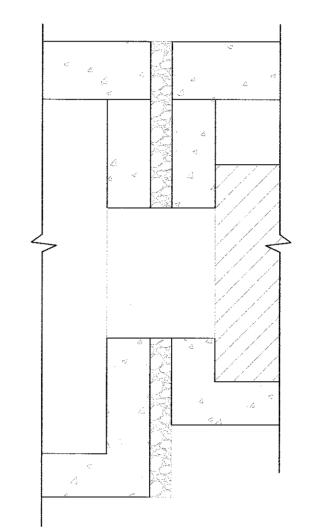

CONTRACTOR IS TO VERIFY THAT ALL INFORMATION SHOWN ON DRAWINGS HAS BEEN THOROUGHLY CHECKED, COMPLIES WITH THE CONTRACT DOCUMENTS, AND IS ADEQUATE TO MEET THE FIELD CONDITIONS. NOTE: PRODUCTION WILL NOT COMMENCE UNTIL RECEIPT OF SIGNED APPROVED

STRUCTURE DESIGN SPECIFICATIONS: PRECAST CONCRETE MINIMUM (28-DAY) STRENGTH 5000 PSI. REINFORCING BARS CONFORMING TO ASTM A 615 (FY=60 KSI). • DESIGN LOAD: AASHTO HS-20 • STRUCTURE DESIGN TO MEET ACI 318.

• CONTRACTOR TO GROUT WITH NON-SHRINK GROUT (MINIMUM 3,000 PSI COMPRESSIVE STRENGTH) BENEATH TOP SLAB TO MATCH FINISHED GRADES.

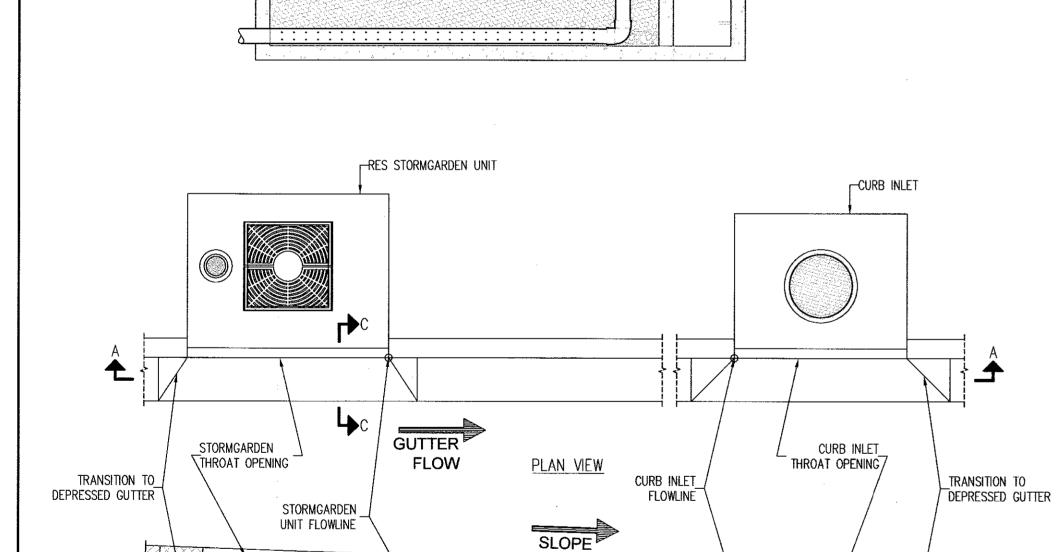


SECTION A-A

GUTTER

DRAINAGE STONE & BEDDING DETAIL

FLOW

DEPRESSED GUTTER

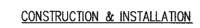

COUPLINGS MARKED 'USE OTHER CONNECTION'.

UNDERDRAIN PIPING

1. DO NOT PLACE IN A SUMP CONDITION. THE STORMGARDEN SYSTEM CANNOT BE USED AS A STANDALONE INLET AND THEREFORE WILL NEED AN EFFECTIVE BYPASS DURING HIGHER INTENSITY RAINFALL EVENTS. REFER TO ATTACHED DETAIL FOR GRADING & GUTTER FLOW DETAILS. TO TEST A PROPOSED LOCATION, IMAGINE THE STORMGARDEN THROAT IS COMPLETELY BLOCKED (SO IT WOULD ACT LIKE A TYPICAL CURB AND GUTTER). IF THIS RESULTS IN ANY PONDING OR POOLING OF DRAINAGE, THE PLACEMENT IS INAPPROPRIATE. IF THE DRAINAGE CONTINUES TO FLOW BY THE BLOCKED STORMGARDEN THROAT TO THE BYPASS INLET (OR OTHER RELIEF) WITHOUT ANY

PONDING OR POOLING, THE PLACEMENT IS APPROPRIATE. 2. EACH UNIT SHALL BE CONSTRUCTED AT THE LOCATIONS AND ELEVATIONS ACCORDING TO THE SIZES SHOWN ON THE APPROVED DRAWINGS. ANY MODIFICATIONS TO THE ELEVATION OR LOCATION SHALL BE AT THE DIRECTION OF AND APPROVED BY THE ENGINEER.

3. THE UNIT SHALL BE PLACED ON THE COMPACTED SUB-GRADE WITH A MINIMUM 6-INCH GRAVEL BASE MATCHING THE FINAL GRADE OF THE CURB LINE IN THE AREA OF THE UNIT. THE UNIT IS TO BE PLACED SUCH THAT THE UNIT AND TOP SLAB MATCH THE GRADE OF THE CURB IN THE AREA OF THE UNIT. COMPACT UNDISTURBED SUB-GRADE MATERIALS TO 95% OF MAXIMUM DENSITY AT +1% TO 2% OF THE OPTIMUM MOISTURE. UNSUITABLE MATERIAL BELOW SUB-GRADE SHALL BE REPLACED TO SITE ENGINEER'S APPROVAL. CONTACT ROTONDO ENVIRONMENTAL SOLUTIONS, LLC FOR GUIDANCE WHERE SLOPE EXCEEDS 5%.

4. ONCE THE UNIT IS SET, THE INTERNAL WOODEN FORMS AND PROTECTIVE SILT FABRIC COVER MUST BE LEFT INTACT. THE TOP LID SHOULD BE SEALED ONTO THE BOX SECTION BEFORE BACKFILLING, USING A NON-SHRINK GROUT, BUTYL RUBBER OR SIMILAR WATERPROOF SEAL. THE BOARDS ON THE TOP OF THE LID AND BOARDS SEALED IN THE UNIT'S THROAT MUST NOT BE REMOVED. IN ORDER TO PREVENT FLOW FROM ENTERING THE DEVICE PRIOR TO ACTIVATION, THE THROAT PROTECTION DEVICE SHALL BLOCK THE ENTIRE EXTENTS OF THE CURB THROAT OPENING. THE ROTONDO ENVIRONMENTAL SOLUTIONS, LLC WILL REMOVE THESE SECTIONS AT THE TIME OF ACTIVATION. 5. OUTLET CONNECTIONS SHALL BE ALIGNED AND SEALED TO MEET THE APPROVED DRAWINGS WITH MODIFICATIONS NECESSARY TO MEET SITE CONDITIONS AND LOCAL REGULATIONS. THE CORRECT OUTLET WILL BE MARKED ON THE STORMGARDEN BOX. DO NOT USE PLUGGED

6. BACKFILLING SHOULD BE PERFORMED IN A CAREFUL MANNER, BRINGING THE APPROPRIATE FILL MATERIAL UP IN 6" LIFTS ON ALL SIDES. PRECAST SECTIONS SHALL BE SET IN A MANNER THAT WILL RESULT IN A WATERTIGHT JOINT. IN ALL INSTANCES, INSTALLATION OF THE STORMGARDEN UNIT SHALL CONFORM TO ASTM SPECIFICATION C891 STANDARD PRACTICE FOR INSTALLATION OF UNDERGROUND PRECAST UTILITY STRUCTURES' UNLESS SPECIFIED OTHERWISE IN CONTRACT DOCUMENTS.

7. IT IS THE RESPONSIBILITY OF THE CONTRACTOR TO PROVIDE CURB AND GUTTER AND TRANSITION TO THE STORMGARDEN UNIT FOR PROPER STORMWATER FLOW INTO THE SYSTEM THROUGH THE THROAT OPENING (SEE ATTACHED DETAILS). HOWEVER, THE PLANS AND CONTRACT DOCUMENTS SUPERSEDE ALL STANDARD DRAWINGS. EFFECTIVE BYPASS FOR THE STORMGARDEN SYSTEM IS ESSENTIAL FOR CORRECT OPERATION (i.E. BYPASS TO AN OVERFLOW AT LOWER ELEVATION). 8. EACH STORMGARDEN UNIT MUST RECEIVE ADEQUATE IRRIGATION TO ENSURE SURVIVAL OF THE LIVING SYSTEM DURING PERIODS OF DRIER

4" TO 6" RIGID

SDR-35

SCHEDULE-40 OR CENTER, 4 HOLES

₹" PERF. @ 6" ON

PER ROW.

BIO-POD UNIT MATERIALS SPECIFICATION MATERIALS **SPECIFICATIONS** SIZE **NOTES** 140 IN/HR BIO-MEDIA RES BIO-MEDIA INFILTRATION RATE SHREDDED MULCH AGED 6-MONTHS HARDWOOD #78 OR #8 UNDERDRAIN STONE WASHED PEA GRAVEL

WEATHER. THIS MAY BE ACHIEVED THROUGH A PIPED SYSTEM, GUTTER FLOW OR THROUGH THE TREE GRATE.


STORMGARDEN REMOVABLE TOP SLAB STORMGARDEN THROAT PROTECTION DEVICE *DO NOT REMOVE* LEAVE IN PLACE UNTIL SITE HAS STABILIZED AND STORMGARDEN UNIT IS ACTIVATED SEE NOTE 4 STORMGARDEN STORMGARDEN BASE SECTION BASE SECTION STORMGARDEN BASE SECTION STORMGARDEN BASE SECTION
STORMGARDEN STORMGARDEN BASE SECTION BASE SECTION BY THE CONTRACTOR
SECTION B-B

∼6" STONE BEDDING

THROAT OPENING DETAIL

DEPRESSED GUTTER-

STORM STRUCTURE SCHEDULE								
STRUCTURE NO.	TYPE	INVERT IN ELEV.	INVERT OUT TOP ELEV. ELEV.		NORTH	EAST	REMARKS	
I1	SINGLE WR INLET MD 374.06	; <u> </u>	747.50	GRATE EL.=751.80	N 620950.4647	E 1264641.1605		
1–2	SINGLE WR INLET MD 374.06	_	741.46	GRATE EL.=745.70	N 620788.8874	E 1264465.47621		
1–3	PRECAST SINGLE WR MD 374.23	740.20	740.00	GRATE EL.=747.50	N 620803.7209	E 1264454.0782		
l-4	PRECAST SINGLE WR MD 374.23		735.13	GRATE EL.=739.10	N 620559.1289	E 1264372.3560		
1–5	STD COG INLET MD 384.41	733.93	733.73	GRATE EL.=741.77	N 620662.0953	E 1264312.4309		
I-6	PRECAST SINGLE WR MD 374.23	731.34	731.14	GRATE EL.=738.30	N 620637.4282	E 1264245.5515		
1–7	SINGLE WR INLET MD 374.06	_	732.46	GRATE EL.=736.7	N 620627.7711	E 1264251.8646		
1–8	STD COG INLET MD 384.41	-	702.00	GRATE EL.=734.0	N 620364.3804	E 1264183.1921		
1-9	PRECAST SINGLE WR MD 374.23		731.14	GRATE EL.=733.50	N 620390.2511	E 1264159.2305		
1-10	PRECAST SINGLE WR MD 374.23	698.83	698.63	GRATE EL.=708.00	N 620346.9684	E 264144.3735		
I – 11	PRECAST SINGLE WR MD 374.23	730.74	730.54	GRATE EL.=734.00	N 620370.7115	E 1264107.9109	,	
I-12	PRECAST SINGLE WR MD 374.23	729.56	729.36	GRATE EL.=734.00	N 620447.6361	E 1264046.7624		
I-13	PRECAST SINGLE WR MD 374.23	728.87	728.67	GRATE EL.=733.90	N 620495.4402	E 1264067.3801		
MH-2		733.50	733.10	GRATE EL.=741.0	N 620679.7170	E 1264297.9719		
EX.MH-1			702.00	GRATE EL.=705.50	N 620529.7469	E 1264010.0722		

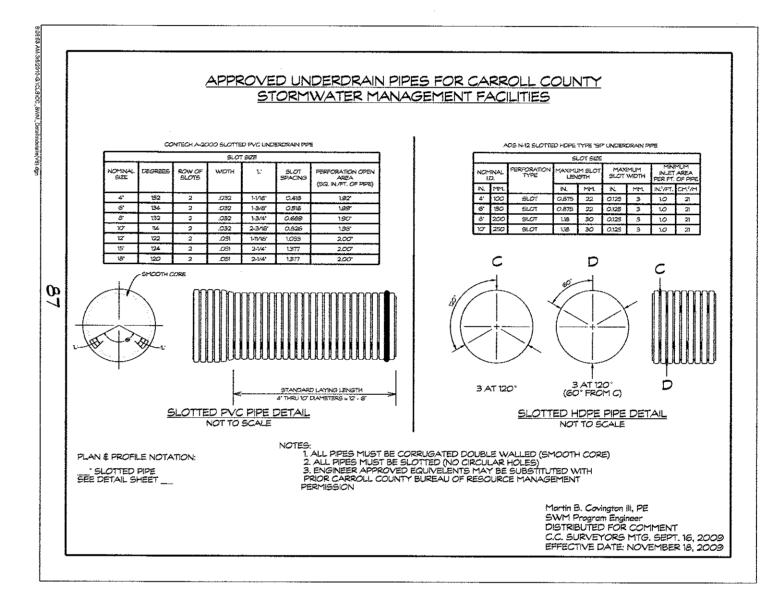

Material	Specification	Size	Notes			
Plantings	See Landscape Plan	N/A	Plantings are site specific and per approved landscape plan			
Mulch	Shredded Hardwood		Aged 6 months, minimum			
Geotextile Class "C" - Apparent opening size (ASTM-D-4751), Grab Tensile Strength (ASTM-D-4632), Puncture Resistance (ASTM-D-4833		N/A	Sides only Not on bottom unless specified on the plans			
Underdrain and Reservoir	AASHTO M-43 No. 8 Stone	3/8" - 1/2"	Stone must be clean and washed			
Underdrain Piping Slotted PVC or Slotted HDPE Type "SP" Pipes Solid: Scheduled 40 PVC or HDPE Type S		See Plan	Refer to the Carroll County SWM Supplement Pg. 87 All pipes must be double walled (smooth core) and slotted (no circular holes)			
Sand	ASTM-C-33 (3 parts to 6 within Filter Media)	0.02"- 0.04"	Sand substitutions such as Diabase and Graystone #10 are not accept No calcium carbonate or dolomitic sand substitutions are acceptable. No "rock-dust" can be used for sand. Manufactured sand from approving sources may be used for filters. Manufactured sand may not be used dams.			
Soil	Engineer approved loam with 20% or less clay (1 part to 6 within Filter Media)	N/A				
Wood Chips	Untreated "Green" (2 parts to 6 within Filter Media)	N/A	Untreated "green" wood chips			
Filter/ Planting Media	Comprised of 3 parts sand, 2 parts wood chips, 1 part soil	N/A	See individual material specifications			

OWNER

LDG RIDGEVILLE LLC LEE PLAZA 8601 GEORGIA AVENUE, SUITE 200

> SILVER SPRING, MD 20910 (301) 585-7000

> > DEVELOPER

LDG INC. LEE PLAZA

8601 GEORGIA AVENUE, SUITE 200 SILVER SPRING, MD 20910

(301) 585-7000

PROFESSIONAL CERTIFICATION

I hereby certify that these documents were prepared or approved by me

and that I am a duly licenced professional engineer under the laws of the State of Maryland, License No. 18417, Expiration Date: 9/18/23.

	MONTHLY INSPECTION				
Inspection Item	Inspection Requirements	Remedial Action			
Debris and Trash	Check for trash and debris in facility including inlets, outlets, conveyance systems, and area around facility.	Remove all trash and debris and dispose in an acceptable manner. Unclog all openings.			
Plant Composition and Health	Compare plant composition with approved plans. Check for invasive species or weeds. Check for dead or dying vegetation.	Remove invasive species and weeds. Replace dead plants in accordance with approved landscaping plan.			
Vegetative Cover	Check for channelizing, erosion, and bare spots. Check for vegetation blocking inlet and outlet.	Remove or cut back vegetation around inlet and outlet structures. Mow side slopes when grass exceeds 12 inches in height, but do not mow filter bed. Remove grass clippings. Re-seed or re-plant in accordance with approved landscaping plan.			
Mulch Layer	Check mulch for adequate cover, sediment accumulation, or discoloration.	Replace and remove old mulch and excess sediment. Provide adequate mulch cover according to approved design.			
	SEASONAL INSPECTION AND AFTER A M.	AJOR STORM			
Inspection Item	Inspection Requirements	Remedial Action			
Dewatering	Check ponding level. Surface storage must dewater within 48 hours of rainfall. Noticeable odors, stained water on the filter surface or at the outlet, or the presence of algae or aquatic vegetation are indicators of anaerobic conditions and inadequate dewatering of the facility.	Remove and replace top few inches of media. Confirm adequate dewatering with follow up inspections. If the facility does not function as intended after the above action, the entire system including the underdrain may need refurbishing.			
Erosion	Check inlets, filter bed, outlets, and side slopes for erosion, rills, guillies, and runoff channelization.	Re—grading may be required when concentrated flow causes rills or gullying through the facility. Grade, vegetate, and/or armor to provide stable conveyance in accordance with approved plans.			
Check for accumulated sediment in conveyance systems and on filter bed. Check for clogged openings.		When sediment accumulates to I inch depth, remove sediment. Remove sediment from clogged openings. Dispose of all sediment in an acceptable location.			
Biockages	Check overflow inlet (riser), piping, and underdrain for blockages. Check observation wells for water level.	Clear out any blockages.			
	ANNUAL INSPECTION				
Inspection Item	Inspection Requirements	Remedial Action			
Maintenance Access	Check for accessibility to facility.	Prevent excessive vegetative growth, erosion, and obstructions on access way.			
Flow Conveyance System	Check overflow inlet, piping, and bypass for misalignments, breakage, and blockage.	Repair any broken or faulty piping. Clear out any blockages.			
Structural Components	Check for evidence of structural deterioration, spalling, or cracking. Inlet and outlet structures as well as riprap outfalls must be in good condition.	Repair to good condition according to specifications on the approved plans.			
Overall Function of Facility	Check that practice is functioning as designed.	Repair to good condition according to specifications on the approved plans.			

CARROLL COUNTY FILE # S-20-0033

CONCEPT SITE PLAN

STORM WATER MANAGEMENT DETAILS

LOT 18A, SECTION II

TWIN RIDGE PROFESSIONAL PARK TAX MAP: 90D, PARCEL 1408 PB 74. PG.119 SITUATED ON RISING RIDGE ROAD, TOWN OF MOUNT AIRY 18TH ELECTION DISTRICT CARROLL COUNTY, MARYLAND




DATE REVISIONS

SYONAL

SCALE: AS SHOWN MAY 2021 → VANMAR ASSOCIATES, INC. | Engineers Surveyors Planners 310 South Main Street Mount Airy, Maryland 21771 (301) 829-2890 (301) 831-5015 (410) 549-2751 vanmar.com Fax (301) 831-5603 @Copyright, Latest Date Shown

SHEET NO. 6 OF 11

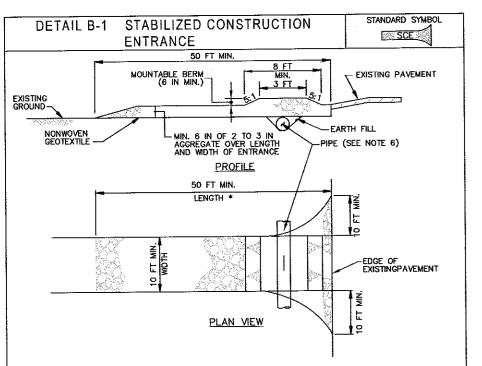

CONSTRUCTION SPECIFICATIONS

PLACE STABILIZED CONSTRUCTION ENTRANCE IN ACCORDANCE WITH THE APPROVED PLAN. VEHICLES MUST TRAVEL OVER THE ENTIRE LENGTH OF THE SCE. USE MINIMUM LENGTH OF 50 FEET (*30 FEET FOR SINGLE RESIDENCE LOT). USE MINIMUM WIDTH OF 10 FEET. FLARE SCE 10 FEET MINIMUM AT THE EXISTING ROAD TO PROVIDE A TURNING RADIUS.


PIPE ALL SURFACE WATER FLOWING TO OR DIVERTED TOWARD THE SCE UNDER THE ENTRANCE, MAINTAINING POSITIVE DRAINAGE, PROTECT PIPE INSTALLED THROUGH THE SCE WITH A MOUNTABLE BERM WITH 5:1 SLOPES AND A MINIMUM OF 12 INCHES OF STONE OVER THE PIPE, PROVIDE PIPE AS SPECIFIED ON APPROVED PLAN. WHEN THE SCE IS LOCATED AT A HIGH SPOT AND HAS NO DRAINAGE A PIPE IS NOT NECESSARY. A MOUNTABLE BERM IS REQUIRED WHEN SCE IS NOT


PREPARE SUBGRADE AND PLACE NONWOVEN GEOTEXTILE, AS SPECIFIED IN SECTION H-1 MATERIALS.

REBAR) AT LEAST 6 INCHES DEEP OVER THE LENGTH AND WIDTH OF THE SCE. MAINTAIN ENTRANCE IN A CONDITION THAT MINIMIZES TRACKING OF SEDIMENT. ADD STONE OR MAKE OTHER REPAIRS AS CONDITIONS DEMAND TO MAINTAIN CLEAN SURFACE, MOUNTABLE BERM, AND SPECIFIED DIMENSIONS. IMMEDIATELY REMOVE STONE AND/OR SEDIMENT SPILLED, DROPPED, OR TRACKED ONTO ADJACENT ROADWAY BY VACUUMING, SCRAPING, AND/OR SWEEPING. WASHING ROADWAY TO REMOVE MUD TRACKED ONTO PAVEMENT IS NOT ACCEPTABLE UNLESS WASH WATER IS

DIRECTED TO AN APPROVED SEDIMENT CONTROL PRACTICE.

MARYLAND STANDARDS AND SPECIFICATIONS FOR SOIL EROSION AND SEDIMENT CONTROL

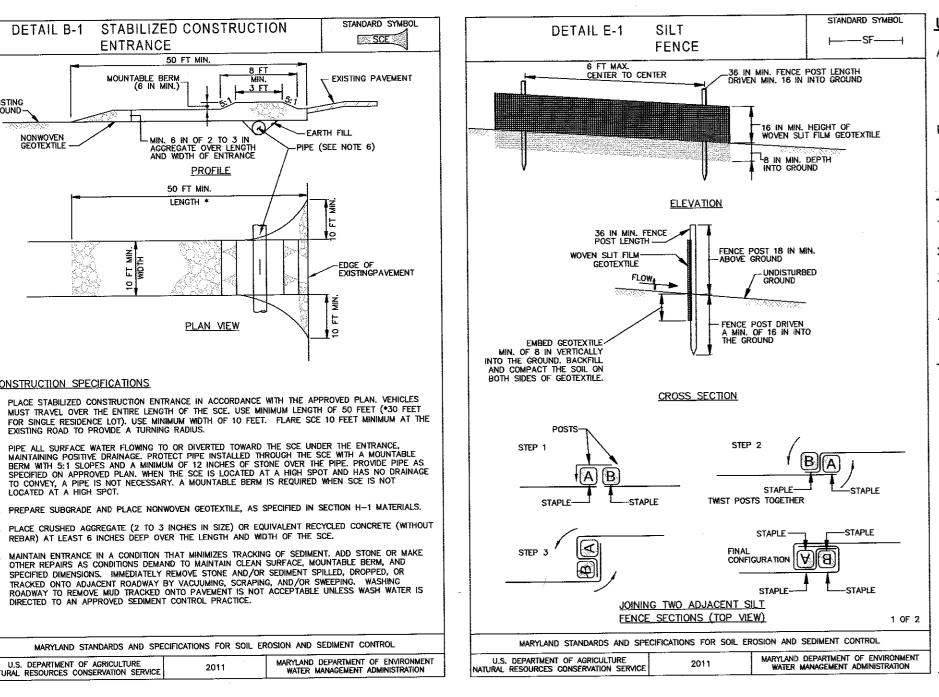

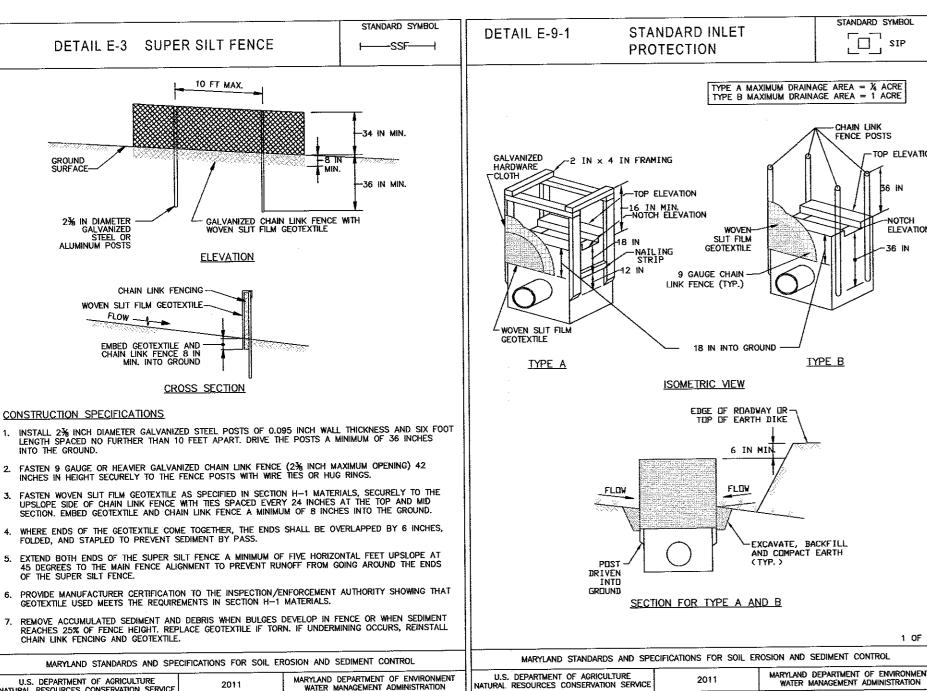

SEDIMENT AND EROSION CONTROL NOTES

1. All erosion/sediment control measures shall comply with the "Maryland Standards and Specifications for Soil Erosion and Sediment Control" by the Maryland Department of the Environment, Water Management Administration in association with the Natural Resources Conservation Service and the Maryland Association of Soil Conservation Districts (referenced as the 2011 Standards and Specs).

2. Areas that have been cleared and/or graded, but will not be constructed on or permanently vegetated for more than 5 days (3 days for sediment control measures and for steep slopes) must be stabilized with mulch or temporary stabilization. Any areas that are in temporary vegetation for over 6 months will need to be permanently vegetated.

- 3. For specifications on permanent or temporary stabilization, see B-4-4 and
- 4. Mulching only is restricted to use on disturbed areas as a temporary cover where vegetation is not feasible or where seeding germination cannot be B. SEVEN (7) CALENDAR DAYS AS TO ALL OTHER DISTURBED OR GRADED AREAS ON completed because of weather conditions. For specifications see B-4-3, A.1.B
- 5. For specifications on the stabilization of cut and fill slopes steeper than 3 horizontal to 1 vertical, see Incremental Stabilization B-4-1
- 6. The existing topsoil from on or off site that is used must meet the

by the Soil Conservation District.

- minimum specification in B-4-2 7. The required sequence of construction must be followed during site development. Any changes in the sequence of construction must be approved
- 8. Any revisions to the sediment control plan, not covered under the list of plan modifications that can be approved by the sediment control inspector, need to be submitted to the Soil Conservation District for approval.
- 9. No proposed slope that is required to be seeded and/or mulched shall be steeper than 2:1. Slopes steeper then 2:1 shall require a engineered design for
- 10. All sediment control structures will be inspected once a week and after each rainfall and will be repaired, as needed, so that the structure meets the minimum specifications as shown in the 2011 Standards and Specs.
- 11. The contractor is responsible for maintaining all sediment and erosion control measures until the disturbed areas are permanently stabilized.
- 12. The district approval for this sediment control plan is good for 2 years. At the end of 2 years, if construction of the plan has not started, the plan will need to be resubmitted to the Soil Conservation District for review and re-approval. Any plans that are currently under construction after 2 years may be required to be resubmitted to the Soil Conservation District by the sediment control inspector.

DUST CONTROL

DUST CONTROL METHOD FOR THIS SITE TO PREVENT BLOWING AND MOVEMENT OF DUST FROM EXPOSED SOIL SURFACES: CALCIUM CHLORIDE SHALL BE APPLIED TO EXPOSED SURFACES AT A RATE THAT WILL KEEP SURFACE MOIST UNTIL SOIL IS STABILIZED ACCORDING TO VEGETATIVE SPECS. FOR THIS SITE AND AREAS TO BE PAVED ARE COMPLETED.

STANDARD STABILIZATION NOTE

FOLLOWING INITIAL SOIL DISTURBANCE OR RE-DISTURBANCE, PERMANENT OR TEMPORARY STABILIZATION MUST BE COMPLETED WITHIN: A. THREE (3) CALENDAR DAYS AS TO THE SURFACE OF ALL PERIMETER DIKES, SWALES, DITCHES, PERIMETER SLOPES, AND ALL SLOPES STEEPER THAN 3 HORIZONTAL TO 1 VERTICAL (3:1); AND

THE PROJECT SITE NOT UNDER ACTIVE GRADING.

TEMPORARY STOCKPILE NOTE

SITE EARTHWORK HAS BEEN BALANCED SUCH THAT A TEMPORARY STOCKPILE SHOULD NOT BE NECESSARY. SHOULD CONTRACTOR DECIDE TO USE A STOCKPILE, CONTRACTOR SHALL PLACE STOCKPILE ON SUITABLE AREA OF THE SITE AND FOLLOW TEMPORARY STABILIZATION NOTES.

UTILITY NOTE FOR SECONDARY UTILITY WORK


- ALL DISTURBANCES FROM SECONDARY UTILITY'S SUCH AS PHONE CABLE, ELECTRIC CABLE, T.V. CABLE, ETC. WILL BE SUBCONTRACTORS RESPONSIBILITY TO BRING WORK AREA BACK TO GRADE LEVEL THAT WAS EXISTING AND MULCH ANY DISTURBANCE FROM INSTALLATION OF LINES OR CONDUIT.
- SUB CONTRACTORS WILL BE RESPONSIBLE FOR RE-INSTALLING OR REPAIRING ANY SILT FENCE OR SEDIMENT CONTROLS THAT WERE EXISTING TO MAINTAIN PROPER SEDIMENT CONTROL THAT MIGHT HAVE BEEN DAMAGED.

FOR UTILITY WORK ONLY OR FOR OFF-SITE UTILITY WORK

- . CAN NOT EXCEED 5,000 SQUARE FEET
- 2. PLACE ALL EXCAVATED MATERIAL ON HIGH SIDE OF TRENCH.
- ONLY DO AS MUCH WORK AS CAN BE DONE IN ONE DAY SO BACKFILLING FINAL GRADING, SEEDING AND MULCHING CAN OCCUR.
- ANY SEDIMENT CONTROL MEASURES DISTURBED BY CONSTRUCTION WILL BE REPAIRED THE SAME DAY.

DISTURBED AREA QUANITY

TOTAL SITE AREA IS ____ 3.47± AC. THE TOTAL AREA TO BE DISTURBED SHOWN ON THESE PLANS HAS BEEN DETERMINED TO BE APPROXIMATELY 147,238± S.F. AND THE TOTAL AMOUNT OF EXCAVATION AND FILL SHOWN ON THESE PLANS HAS BEEN COMPUTED TO BE APPROXIMATELY __500 C.Y. OF EXCAVATION AND APPROXIMATELY /500 C.Y. OF FILL

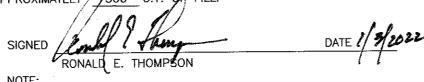

FARTHWORK CUT AND FILL QUANTITIES AND AREA OF DISTURBANCE

INDICATED ON THIS PLAN ARE SHOWN FOR PURPOSE OF OBTAINING

SEDIMENT CONTROL PLAN APPROVAL AND ARE NOT TO BE USED FOR

EGETATIVE SPECIFICATIONS AND NOTES

CONTRACTUAL OBLIGATION.

DISTURB AS SMALL AN AREA OF THE PRESENT COVER AS POSSIBLE WHILE PERFORMING GRADING. FSTABLISH PERMANENT VEGETATIVE COVER IMMEDIATELY AFTER FINAL GRADING IS COMPLETED. (THIS INCLUDES ALL GRADING ON OR OFF THIS SITE THAT IS AFFECTED BY THIS CONSTRUCTION.) IF FINAL GRADING IS COMPLETED AT A TIME OTHER THAN THE SEEDING SEASON, A TEMPORARY GROUND COVER SUCH AS MULCHING

STRAW AT 1.5 TONS PER ACRE

SS-1 OR EQUIVALENT AT 200 GAL, PER ACRE

SS-1 OR EQUIVALENT AT 200 GAL. PER ACRE

- WILL BE USED TO STABILIZE THE BARE SOIL. RECOMMENDED TEMPORARY SEED MIXTURE: BALBOA RYE AT 150 LBS. PER ACRE 2 TONS GROUND LIMESTONE PER ACRE 10-10-10 AT 1,000 LBS. PER ACRE FERTILIZER:
- RECOMMENDED PERMANENT SEED MIXTURE: KY-31 FESCUE AT 60 LBS. PER ACRE 2 TONS GROUND LIMESTONE PER ACRE 10-10-10 AT 1,000 LBS. PER ACRE FERTILIZER: STRAW AT 1.5 TONS PER ACRE MUI CH:

STOCKPILE NOTES:

MULCH:

ASPHALT:

ASPHALT:

- NO STOCKPILING ALLOWED ON ASPHALT.
- ALL STOCKPILES LEFT AT THE END OF THE NEXT DAY NEED TO BE STABILIZED UNTIL THE NEXT REDISTURBANCE.

TEMPORARY SEEDING NOTES

Scope: Planting short term (no more than 6 Months) vegetation to temporarily stabilize any areas where soil disturbance has occurred, until the area can be permanently stabilized with vegetative or non-vegetative practices.

Standards: The following notes shall conform to Section B-4 of the 2011 MARYLAND STANDARDS AND SPECIFICATIONS FOR SOIL EROSION AND SEDIMENT CONTROL" published iointly by the Maryland Department of Environment - Water Management Administration, the National Resource Conservation Service and the Maryland Association of Soil Conservation Districts

The seed bed shall be prepared by loosening the soil to a depth of 3 to 5 inches and incorporating the lime and fertilizer into this loosened layer of soil. See section B-4-2 For temporary stabilization, fertilizer shall consist of a mixture of 10-20-20 and be applied at a rate of 436 lb. per acre (10 lb. per 1000 sq. ft.) and will meet the requirements in section B-4-2. Lime shall be applied at a rate of 2 tons per acre (90 11. NOTIFY TOWN OF MOUNT AIRY FOR FINAL INSPECTION OF COMPLETED PROJECT. lb. per sq. ft.) and shall meet the requirements in section B-4-2 and B-4-4

Seed type and application shall meet the requirements in section B-4-3 Seed tags shall be made available to the inspector to verify the type and rate of seed used. Mulch type and its application will meet the requirements in section B-4-3 a, b and c and will be applied along with the seed or immediately after seeding

Seeding mixtures shall be selected from or will be equal to those on Table B.1 (page B.20).

Temporary Seeding Summary The seeding chart below will need to be placed on and filled in on the sediment control plan

Hardiness Zone (from Figure B.3): Seed Mixture (from Table B.1):							Fertilizer Rate	Lime Rate		
No.	Species	Application	Rate (lb/ac)	Seeding	Dates	Seeding	Depths	(10-20-20)		
-								436 lb/ac	2 tons/ac	
-			<u>.</u>			_		(10 lb/1000 sf)	(90 lb/1000	st

PERMANENT SEEDING NOTES

with seed or immediately after seeding

Scope: Planting permanent, long lived vegetative cover on graded and/or cleared areas and areas that have been in temporary vegetation for more than 6 months. Standards: The following notes shall conform to Section B-4 of the "2011 MARYLAND STANDARDS AND SPECIFICATIONS FOR SOIL EROSION AND SEDIMENT CONTROL" published jointly by the Maryland Department of Environment — Water Management Administration, the National Resource Conservation Service and the Maryland Association of Soil Conservation Districts.

The seed bed shall be prepared by loosening the soil to a depth of 3 to 5 inches and incorporating the lime and fertilizer into this loosened layer of soil. See section B-4-


For sites of 5 ac. or less of disturbance, the following fertilizer and lime rates shall apply. Fertilizer shall consist of a mixture of 10-20-20 and be applied at the following rates:

For sites over 5 ac. soil tests will be performed. Soil tests will be conducted by the University of Maryland or a recognized commercial laboratory. Minimum soil conditions shall meet the requirements of section B-4-2-A-2-a, otherwise soil amendments or topsoil will need to be applied. Topsoiling may occur when soil conditions meet the minimum requirements as stated in section B-4-2-B. Soil amendments must meet the requirements as set forth in section B-4-2-C and must be applied as indicated by the soils tests.

N = 45 lb. per acre (1 lb. per 1000 sq.ft.) P205 = 90 lb. per acre (2 lb. per 1000 sq.ft.) K20 = 90 lb. per acre (2 lb. per 1000 sq.ft.) Lime shall be applied at a rate of 2 tons per acre (90 lb. per 1000 sq.ft.) Seed type, turfgrass or sod application shall meet the requirements in section B-4-5. Seed tags shall be made available to the inspector to verify the type and application rate of seed used. Mulch type and its application will meet the requirements in section B-4-3 a, b and c, and will be applied along

Seeding mixtures shall be selected from or will be equal to those on Table B-3. The seeding chart below will need to be placed on and filled in on the sediment control plan

Hardiness Zone (from Figure B.3): Seed Mixture (from Table B.3):					F	Lime Rate		
No. Species		Application Rate (lb/ac)	Seeding Dates	Seeding Depths	N	P205	K20	
				1/4-1/2 in	45 pounds	90 lb/ac (2	90 lb/ac (90 lb/1000 st)	2 tons/ac
				1/4-1/2 in		lb/1000 st)	lb/1000 st)	(90 lb/ 1000 sf)
				1/4-1/2 in	(1.0 lb/ 1000 sf)			

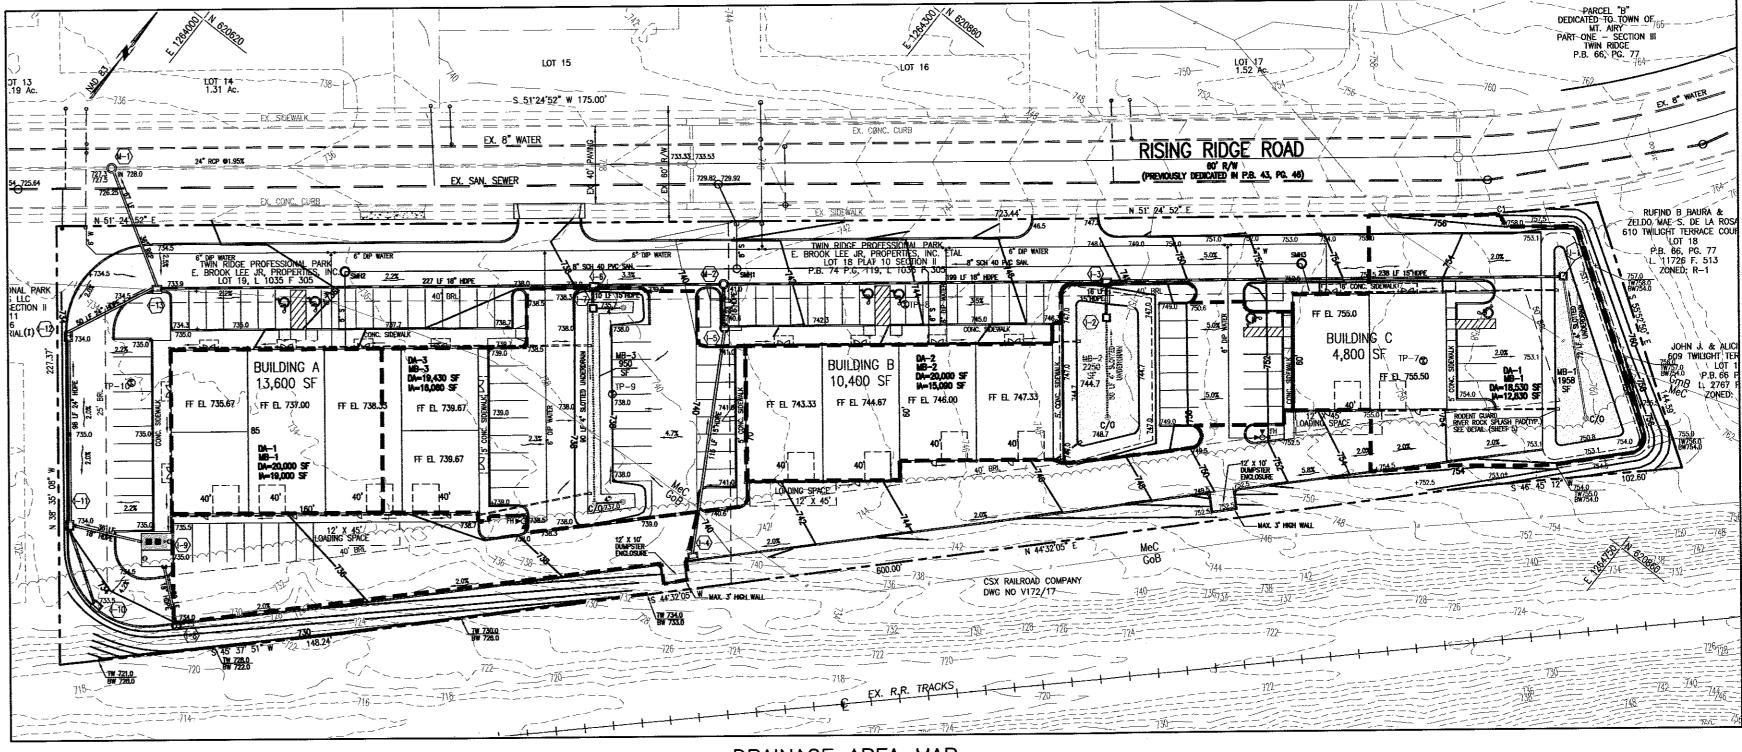

SEQUENCE OF CONSTRUCTION

- OBTAIN ALL REQUIRED GRADING, MDE PERMITS, APPROVALS AND LICENSES FROM APPROPRIATE AGENCIES.
- NOTIFY SEDIMENT CONTROL INSPECTOR (410) 386-2210 AT LEAST THREE (3) WORKING DAYS PRIOR TO STARTING WORK.
- 3. INSTALL STABILIZED CONSTRUCTION ENTRANCE AND SEDIMENT CONTROL PROTECTION
- UPON COMPLETION OF ALL SEDIMENT CONTROL MEASURES, SECURE PERMISSION FROM INSPECTOR BEFORE PROCEEDING. CONTRACTOR SHALL HAVE THE OPTION TO PROCEED WITH THE GRADING OPERATION PRIOR TO HAVING ALL SEDIMENT CONTROL MEASURES FOR THE SITE IN PLACE PROVIDED APPROVAL IS OBTAINED FROM THE INSPECTOR FOR THE AREAS WHERE SEDIMENT CONTROL MEASURES ARE IN PLACE AND FUNCTIONAL.
- 5. STABILIZE ALL THE GRADED AREAS UP TO 20' OUTSIDE OF THE LIMIT OF GRADING AS PER PERMANENT SEEDING NOTES. IN AREAS OF FILL WITH SLOPES, CONTRACTOR SHALL BE PREPARED TO APPLY POLYACRYALAMIDES (PAM) TO THE SLOPES PRIOR TO RAIN EVENTS. SUCH APPLICATION SHALL BE IN CONFORMANCE WITH THE MANUFACTURER'S TECHNICAL SPECIFICATIONS FOR PAM. CONTRACTOR SHALL PRIOR TO THE START OF FILL OPERATIONS, HAVE COMPLETED SOIL SAMPLING OF FILL MATERIAL TO DETERMINE PAM AND SEED MIXTURE.
- 6. COMPLETE SITE GRADING AFTER INSTALLATION OF STORM DRAINS, SANITARY SEWER
- . SIMULTANEOUS WITH SITE GRADING, CONSTRUCT BUILDING AND CONSTRUCTION THROUGH INITIAL BITUMINOUS PAVING COURSE, CONTRACTOR SHALL FOLLOW PLANS TO PROVIDE INLET PROTECTION UNTIL FINAL GRADING AND STABILIZATION OF SURROUNDING EMBANKMENTS/ FILL AREAS.
- 8. UPON COMPLETION OF CURB & GUTTER AND INITIAL PAVEMENT BASE COURSE. CONSTRUCT MICRO BIO RETENTION BASIN (SHEET 5).
- 9. COMPLETE FINAL SITE PAVING AND COMPLETE ANY FINE GRADING OF THE SITE THAT
- 10. UPON COMPLETION OF CONSTRUCTION AND STABILIZATION OF DISTURBED AREAS AND APPROVAL OF SEDIMENT CONTROL INSPECTOR; REMOVE ALL TEMPORARY SEDIMENT CONTROL DEVICES. FILL ALL DISTURBED AREAS AND STABILIZE AREAS IN ACCORDANCE WITH THE MARYLAND STANDARDS AND SPECIFICATIONS FOR SOIL EROSION AND SEDIMENT CONTROL.

DATE REVISIONS

SONAL Y

OWNER

LDG RIDGEVILLE LLC

LEE PLAZA

8601 GEORGIA AVENUE, SUITE 200

SILVER SPRING, MD 20910

(301) 585-7000

DEVELOPER

LDG INC.

LEE PLAZA

8601 GEORGIA AVENUE, SUITE 200

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SILVER SPRING, MD 20910

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and that I am a duly licenced professional engineer under the laws of the State of Maryland, License No. 18417, Expiration Date: 9/18/23.

CARROLL COUNTY FILE # S-20-0033

CONCEPT SITE PLAN

SEDIMENT CONTROL NOTES & DETAILS

LOT 18A, SECTION II


TWIN RIDGE PROFESSIONAL PARK TAX MAP: 90D, PARCEL 1408 PB 74. PG.119 SITUATED ON RISING RIDGE ROAD, TOWN OF MOUNT AIRY 18TH ELECTION DISTRICT CARROLL COUNTY, MARYLAND SCALE: AS SHOWN MAY 2021




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SHEET NO. 7 OF 11

VMA# 251-569



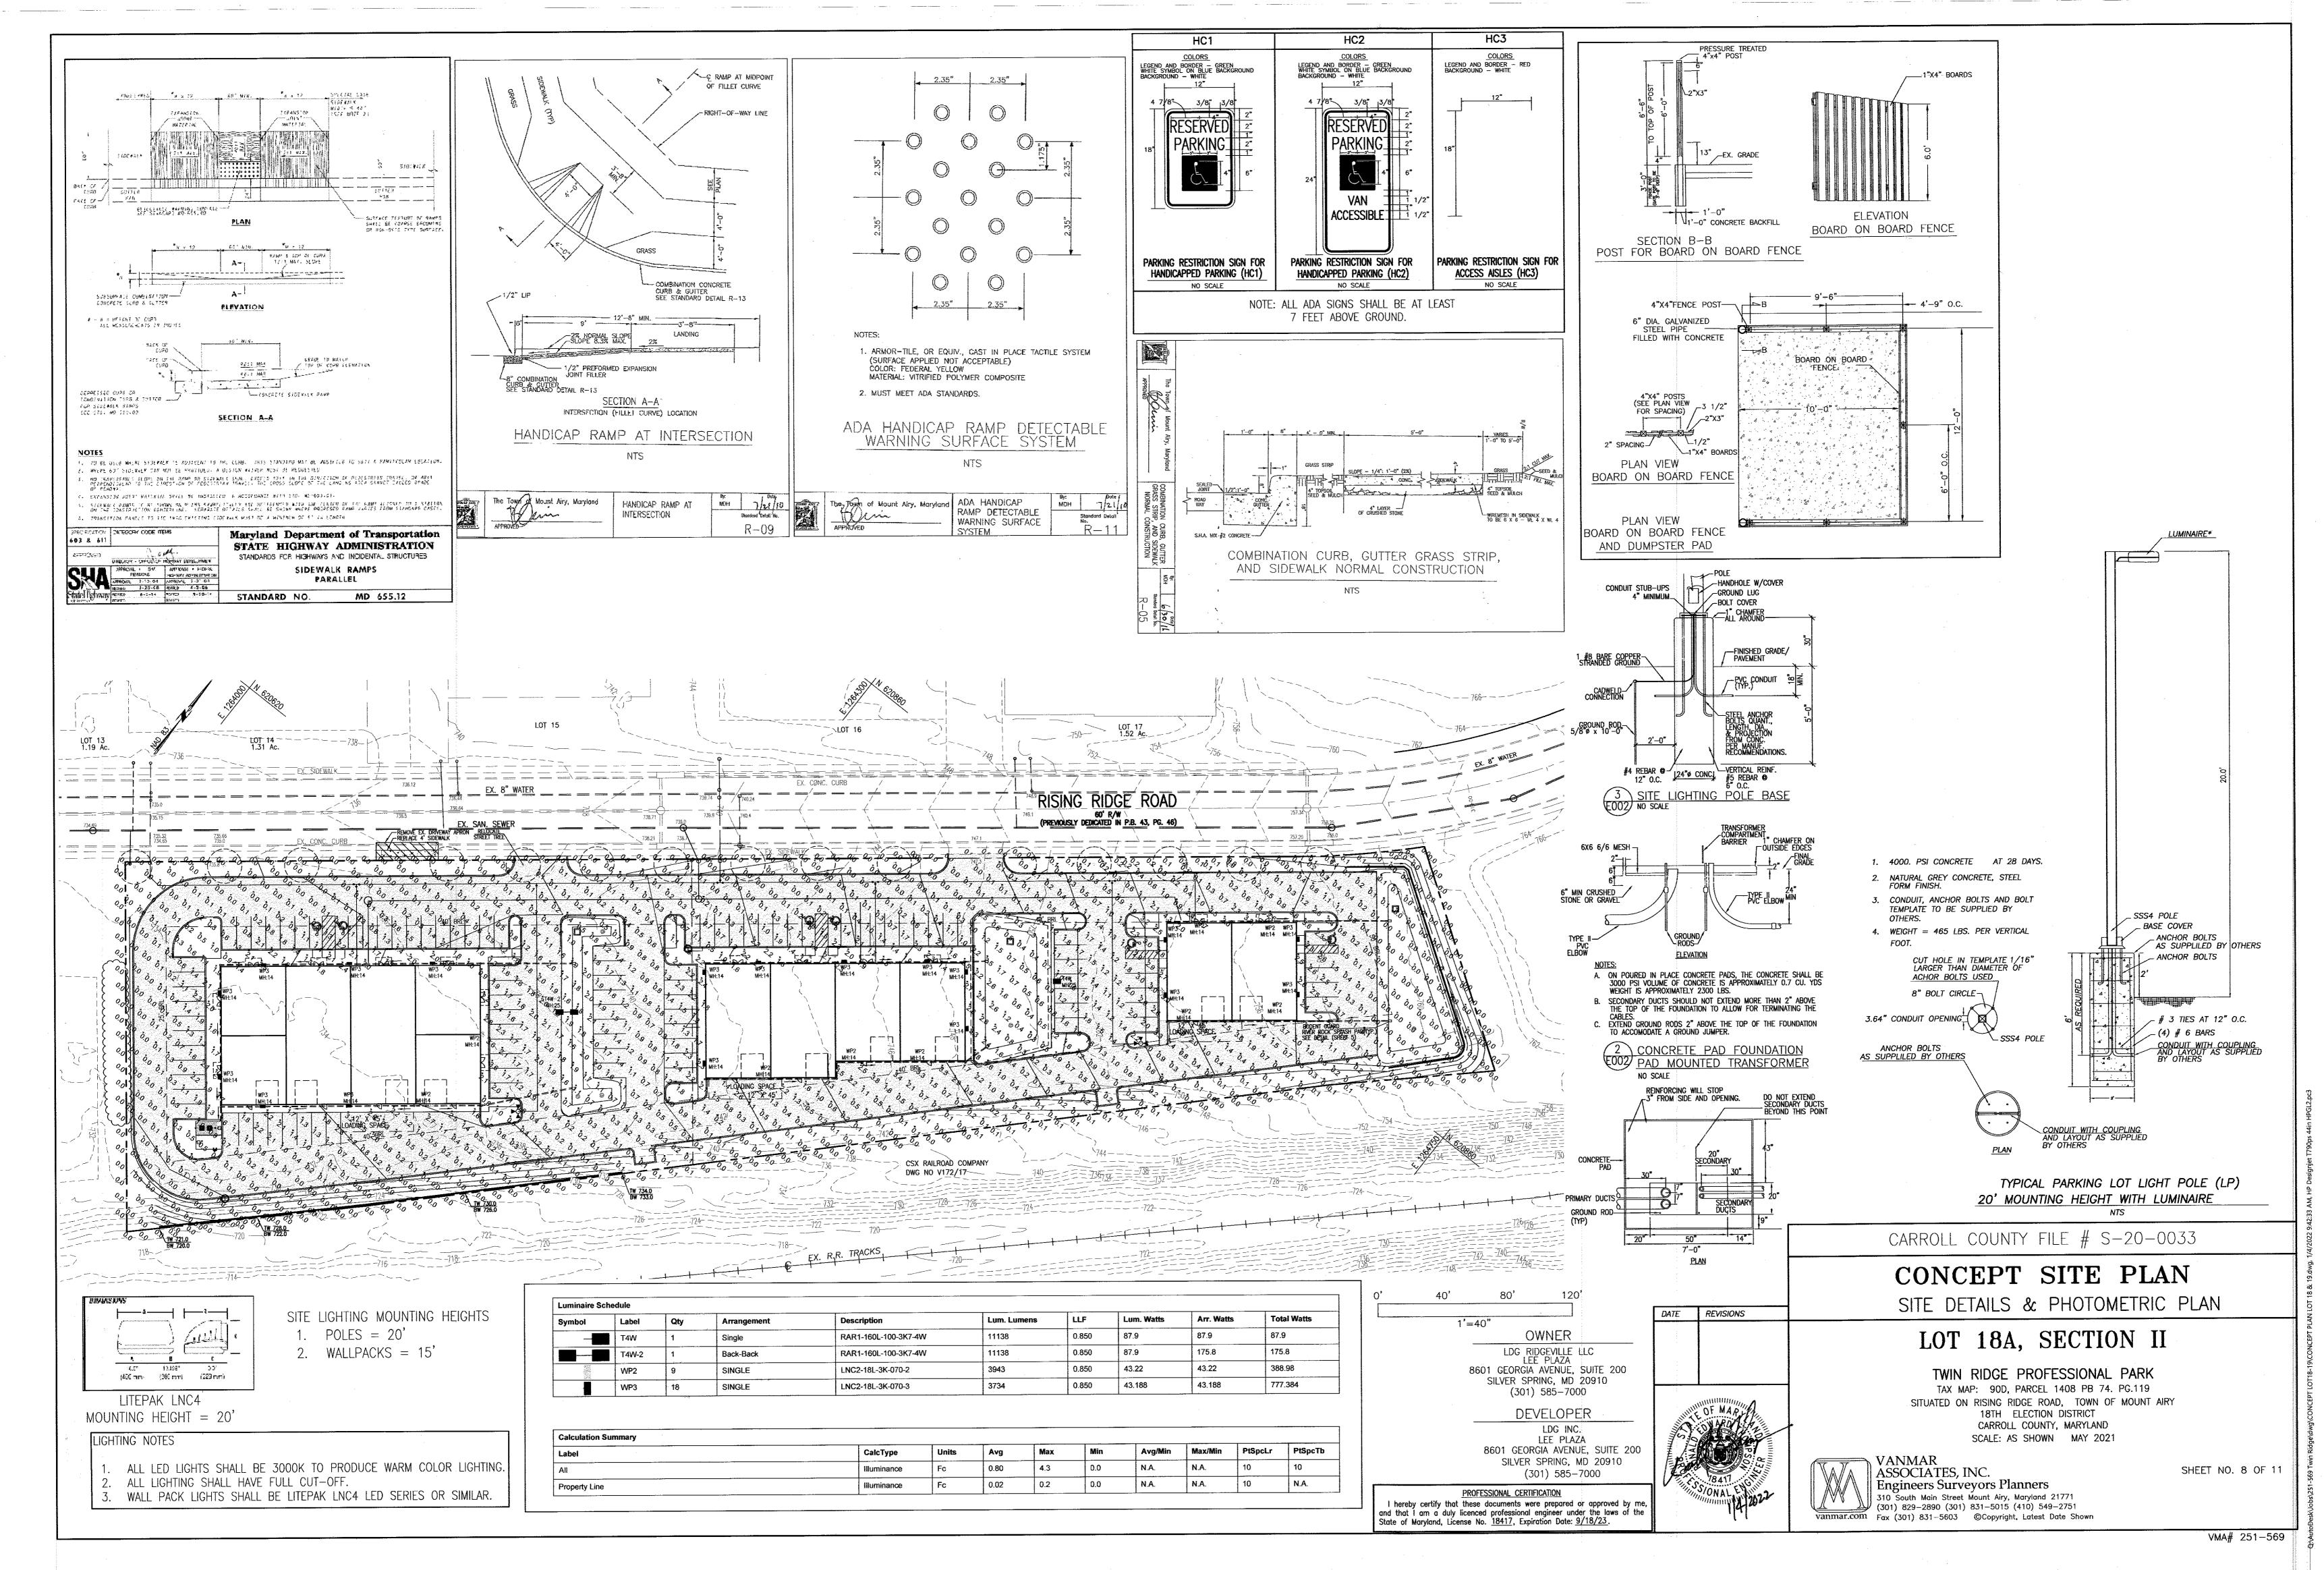

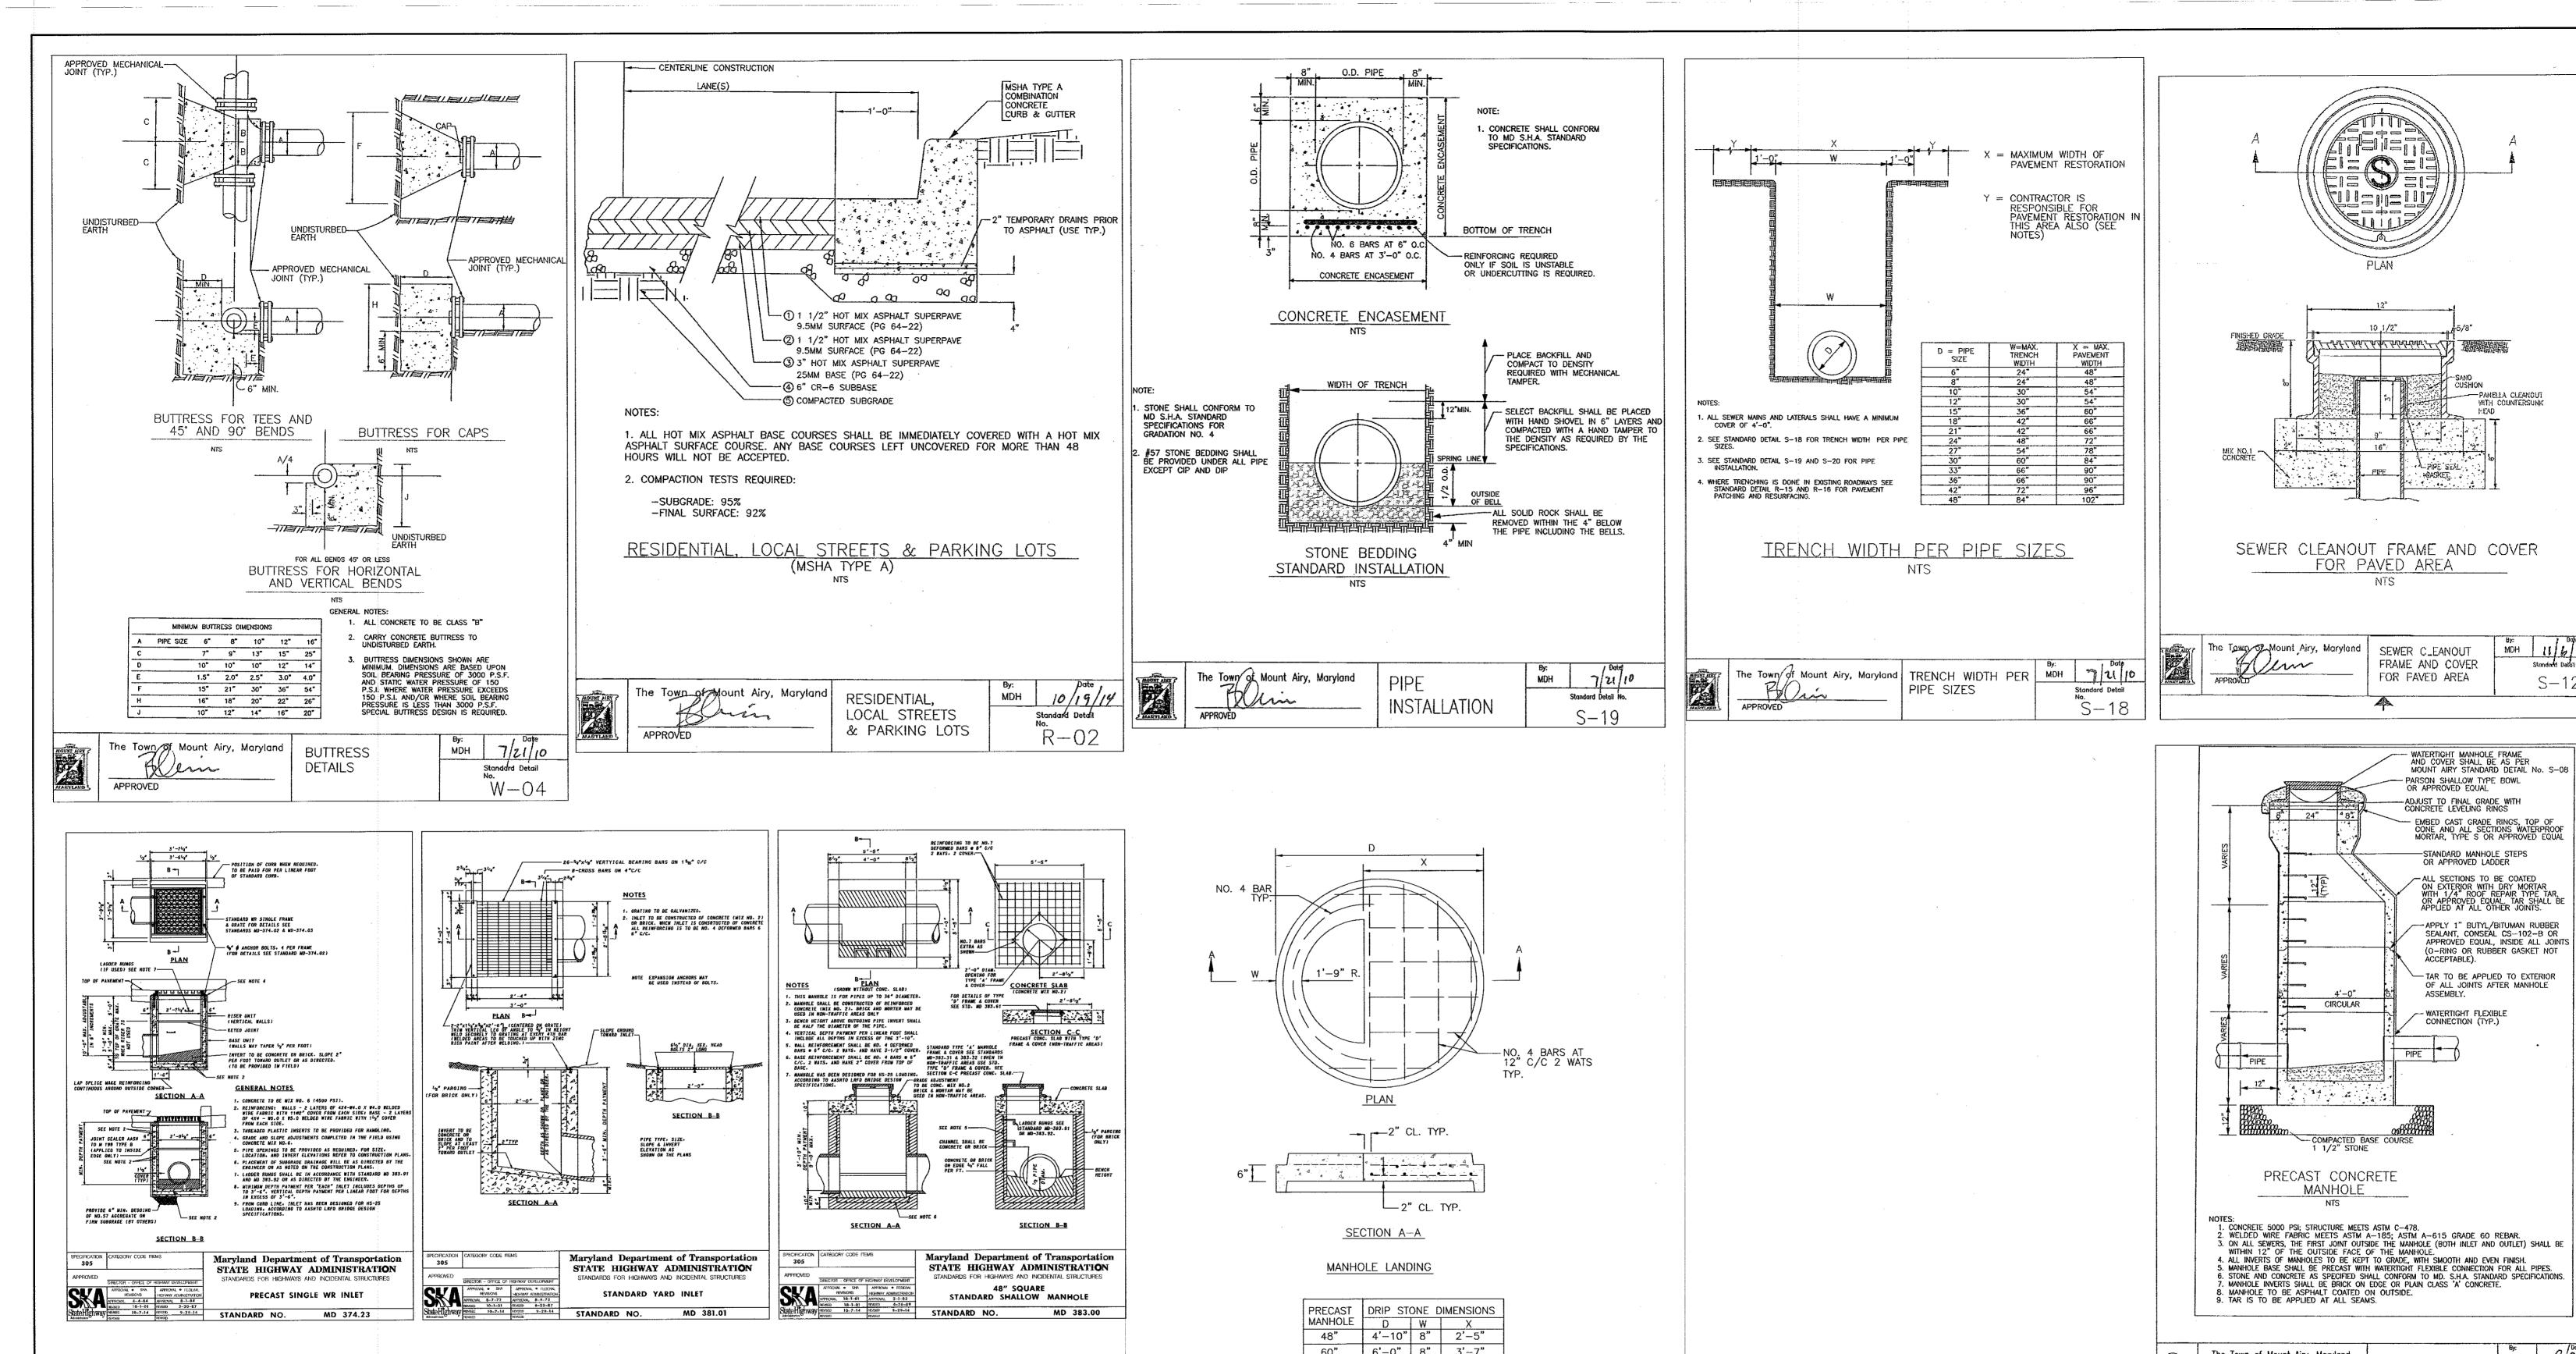7" THICK CONCRETE—

CONC. SIDEWALK

GRASS

__CONTROL JOINT

MIN. 6" THICK 3/4" GRAVEL

RÉAR ELEVATION

31'-0" DRIVEWAY

/2" EXPANSION JOINT FILLER

CONTROL JOINT CONTROL JOINT

CONCRETE APRON 7" THICK-3500 PSI

10 WIREMESH 6X6 FULL LENGTH &— WIDTH OR 6 # 4 BARS @ 12" O.C

PLAN

FRONT ELEVATION

CONCRETE DRIVEWAY APRON DETAIL

1/2" EXPANSION

CONC. SIDEWALK

GRASS

CONCRETE CURB & GUTTER

7'-2" | 8" | 4'-9"

8'-4" 8" 5'-11'

7'-0"


9'-6" 9"

120" 11'-8" 10" 9'-1"

PRECAST DRIP STONE

LANDING DETAILS FOR

48" TO 120" DIAMETER MANHOLES

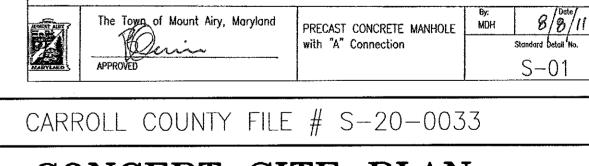

HEAD

S - 12

APPROVED EQUAL, INSIDE ALL JOINTS

(O-RING OR RUBBER GASKET NOT ACCEPTABLE).

- WATERTIGHT FLEXIBLE CONNECTION (TYP.)

CONCEPT SITE PLAN

SITE DETAILS

LOT 18A, SECTION II

TWIN RIDGE PROFESSIONAL PARK TAX MAP: 90D, PARCEL 1408 PB 74. PG.119 SITUATED ON RISING RIDGE ROAD, TOWN OF MOUNT AIRY

18TH ELECTION DISTRICT CARROLL COUNTY, MARYLAND SCALE: AS SHOWN MAY 2021

VANMAR ASSOCIATES, INC. || Engineers Surveyors Planners 310 South Main Street Mount Airy, Maryland 21771 (301) 829-2890 (301) 831-5015 (410) 549-2751

DATE

OWNER

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PROFESSIONAL CERTIFICATION

I hereby certify that these documents were prepared or approved by m


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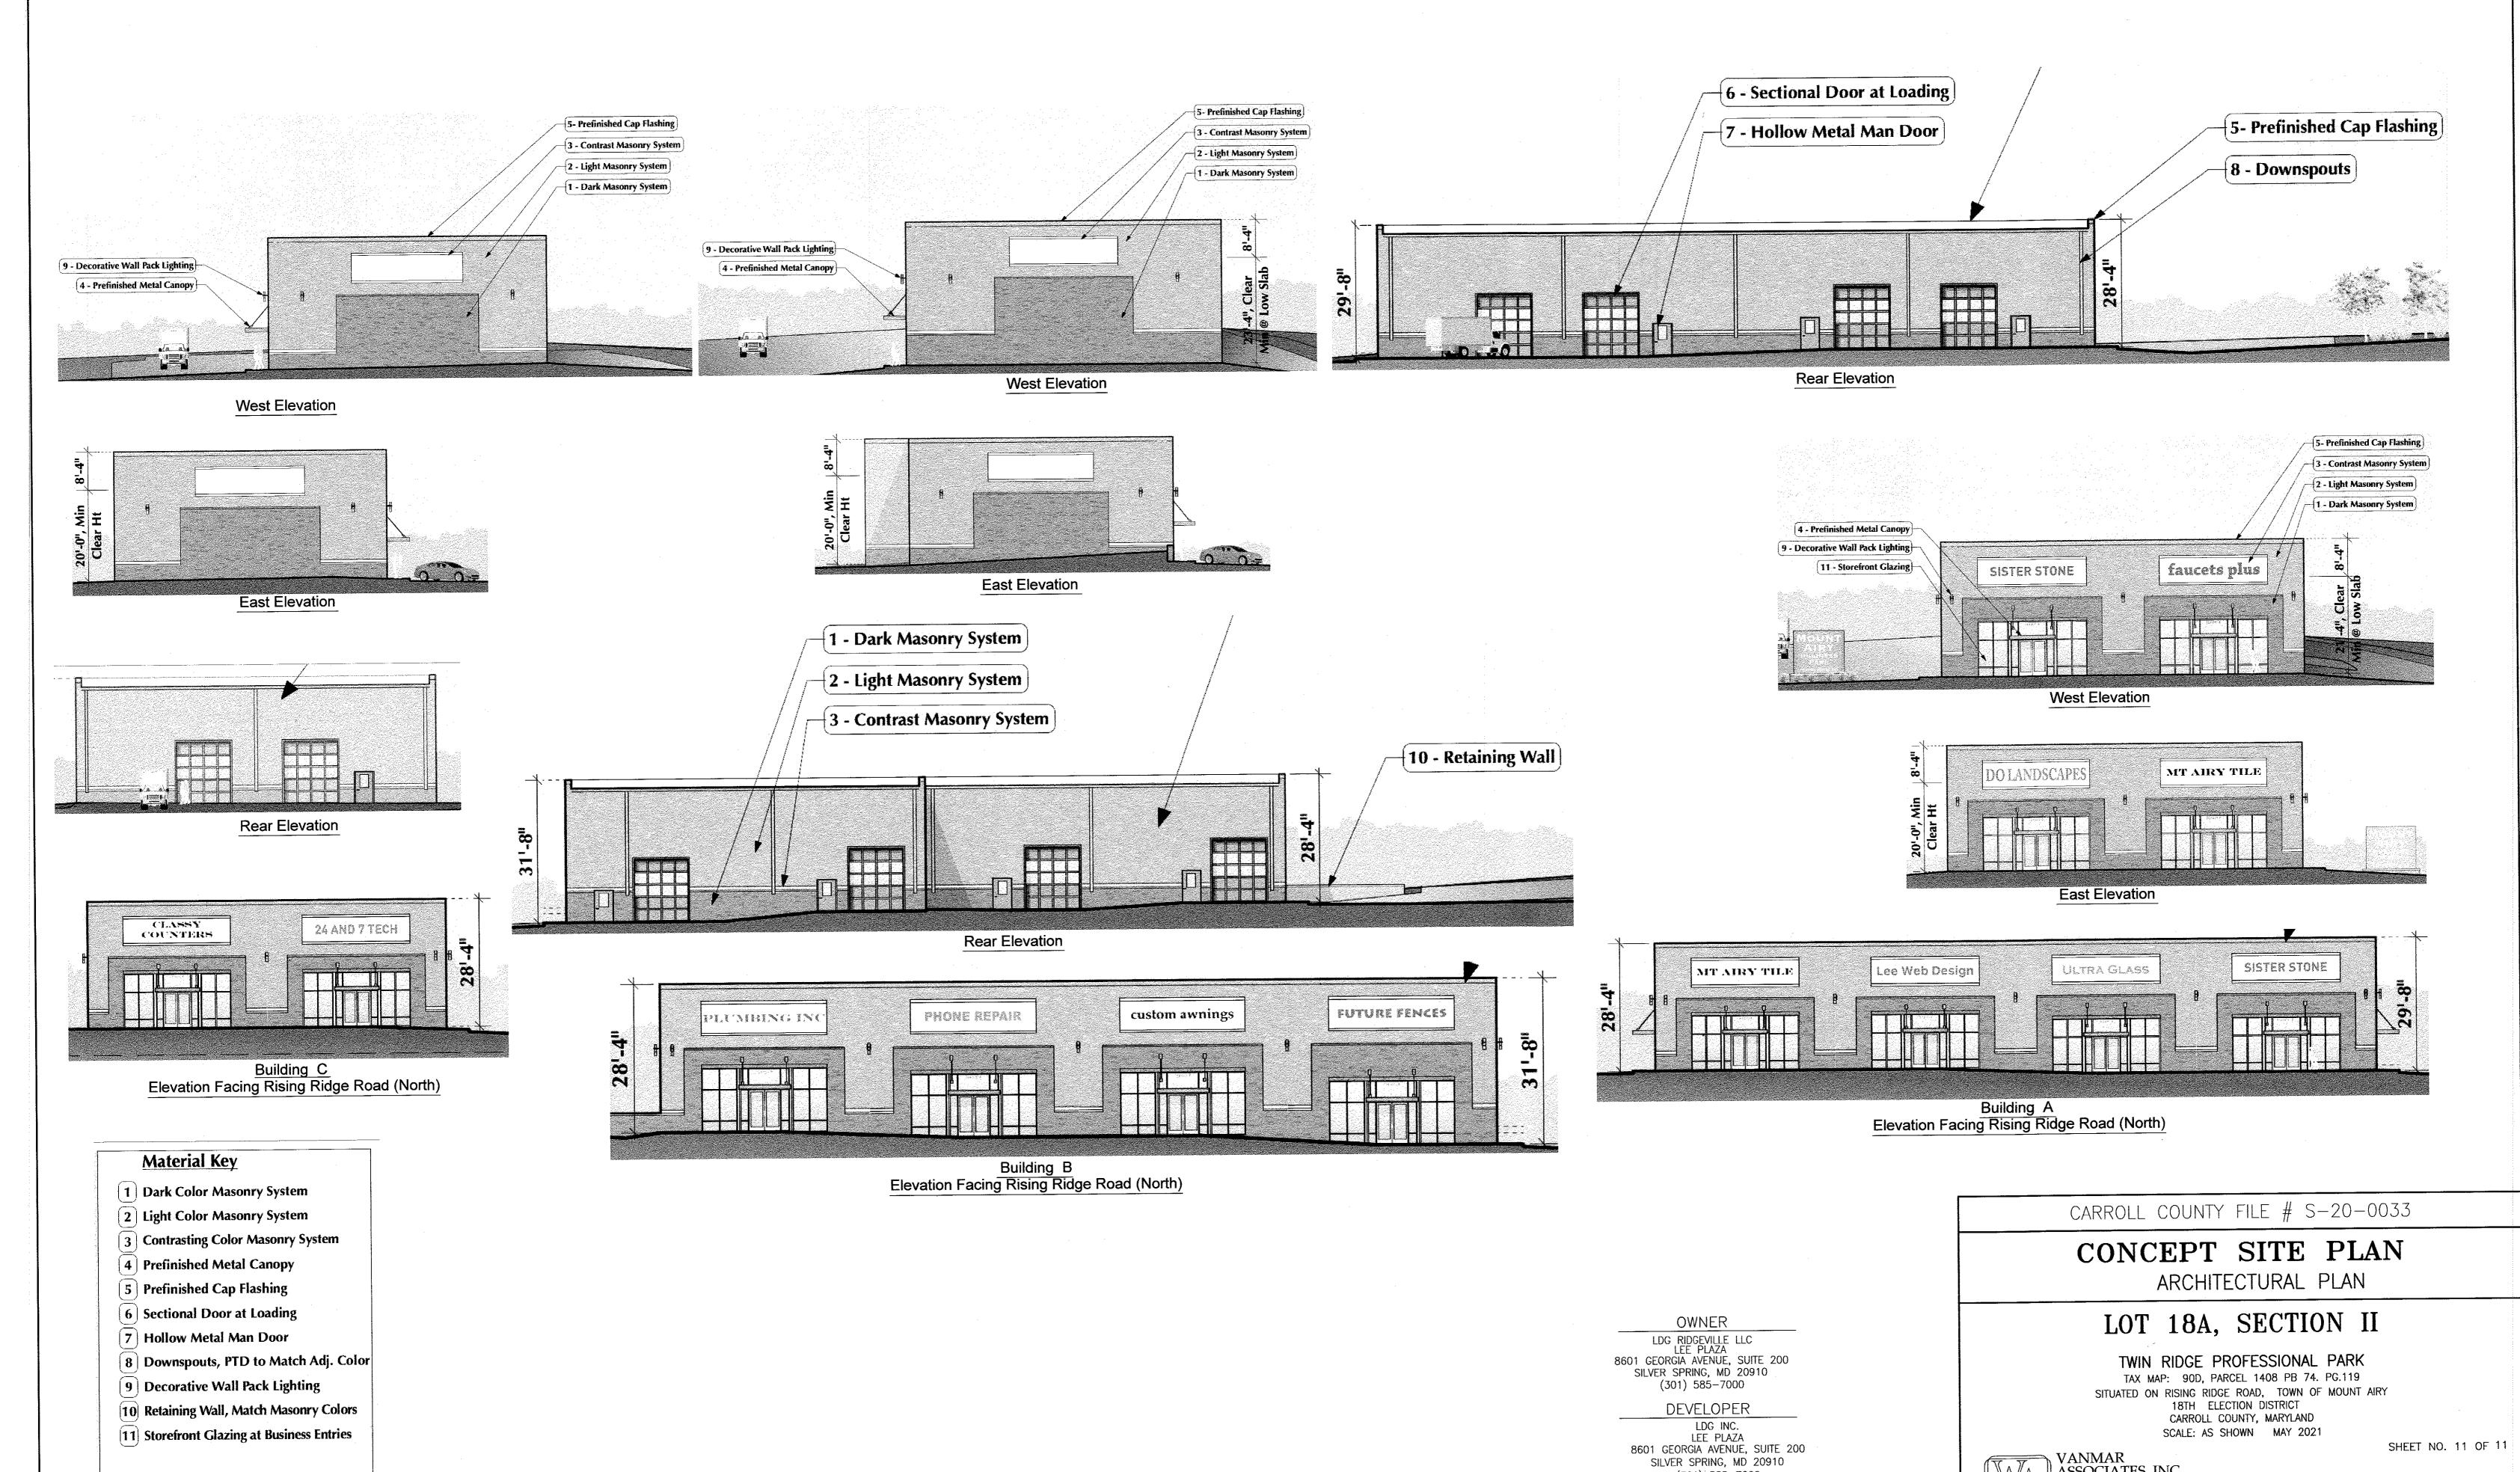
REVISIONS

STONAL

SHEET NO. 9 OF 11

VMA# 251-569



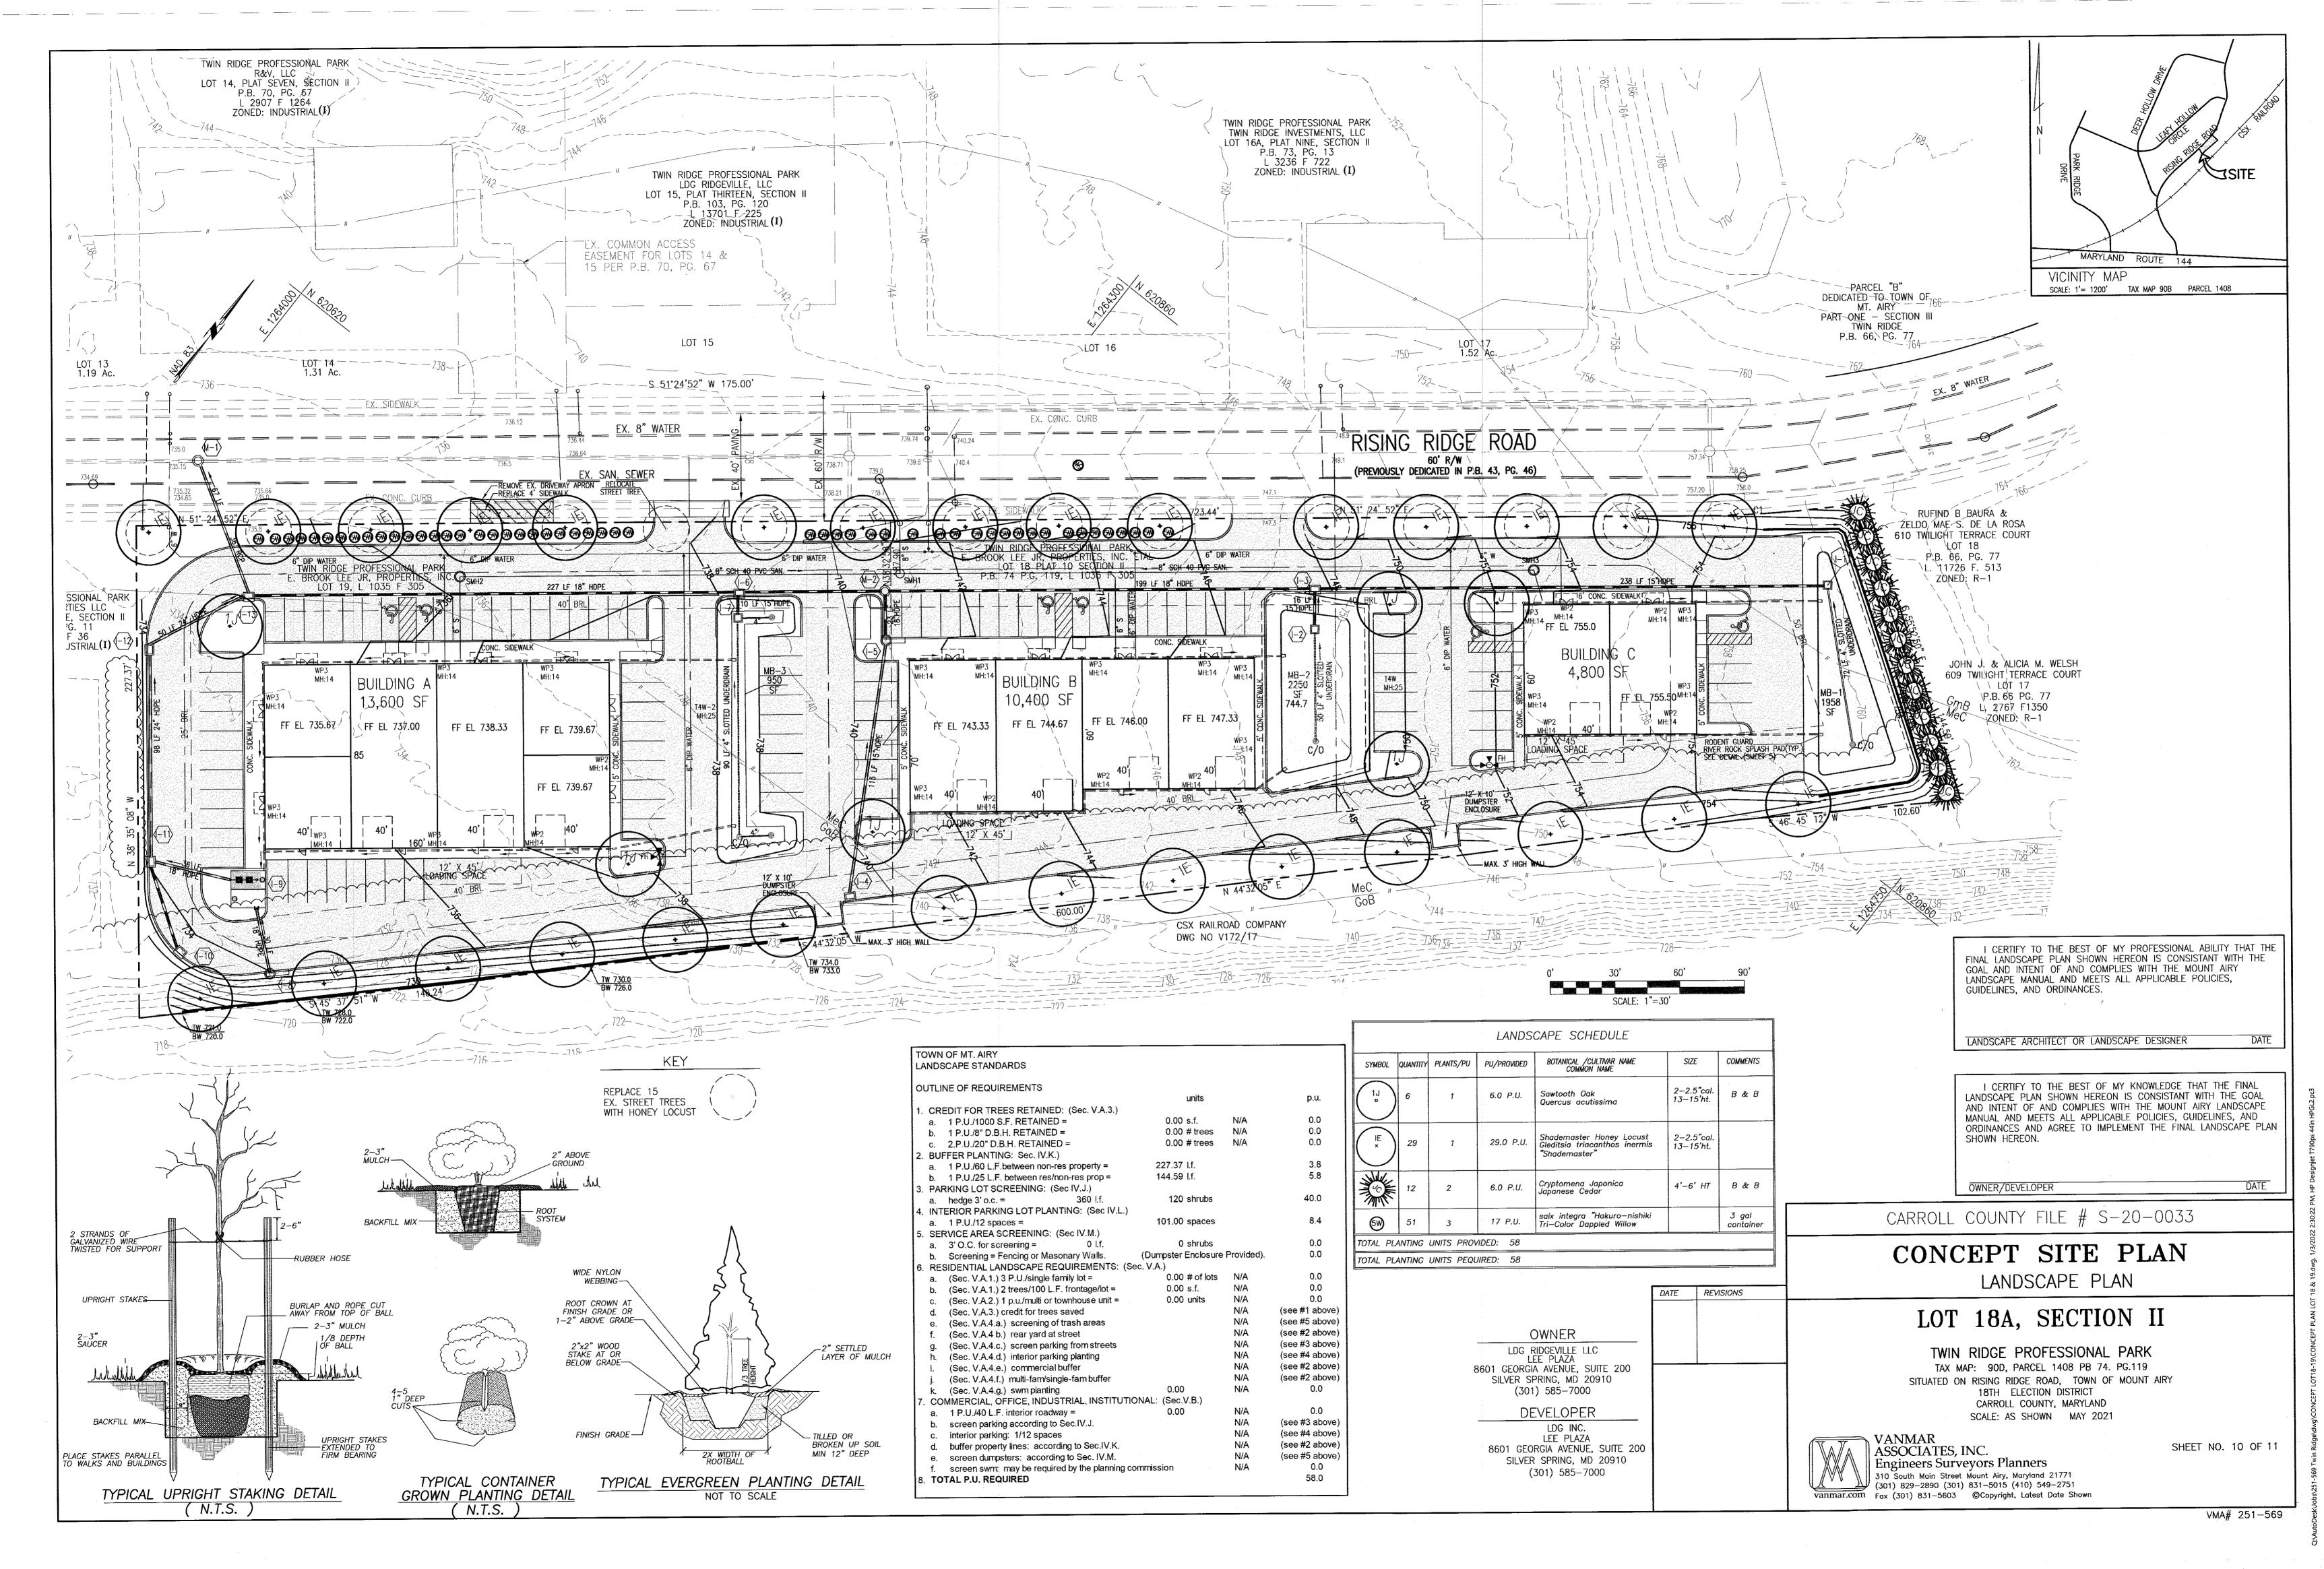

Note: All Colors and Mfrs Subject to

Modification per Final Design

VMA# 251-569

SHEET NO. 11 OF 11

VANMAR
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